MIDDLE TRIBUTARY UPSTREAM OF I-25 CHANNEL RESTORATION

CONSTRUCTION PLANS

100% DESIGN - NOT FOR CONSTRUCTION AUGUST, 2023


PROJECT DESCRIPTION

THE PURPOSE OF THE MIDDLE TRIBUTARY UPSTREAM OF I-25 CHANNEL RESTORATION PROJECT IS TO MITIGATE EXISTING CHANNEL INCISION AND CHANNEL BANK EROSION FOR THE PURPOSE OF RESTORING THE DEGRADED WETLAND HABITAT AND PREBBLES'S MEADOW JUMPING MOUSE HABITAT THAT HAS BEEN AFFECTED BY THESE CHANNEL CONDITIONS.

THE PROJECT INCLUDES 700 FEET OF FULL RESTORATION IN THE UPSTREAM REACH AND SELECTED LONG-TERM DEGRADATION PROJECT IN THE DOWNSTREAM REACH TO MAINTAIN THE EXISTING HABITAT, INCLUDING APPROXIMATELY 100 FEET OF HEADCUT RESTORATION.

REVIEWED BY	
<u>CITY ENGINEER</u>	
BY:	DATE
STORMWATER ENTERPRISE	27
BY:	DATE
COLORADO SPRINGS UTILITIES	DAIL
BY:	
COLORADO SPRINGS UTILITIES ELECTRIC	
BY:	
UNITED STATES AIR FORCE ACADEMY	DATE
10TH CIVIL ENGINEERING SQUADRON	
BY:	
UNITED STATES AIR FORCE ACADEMY	DATE
10TH CIVIL ENGINEERING SQUADRON	
BY:	
	DATE

VICINITY MAP

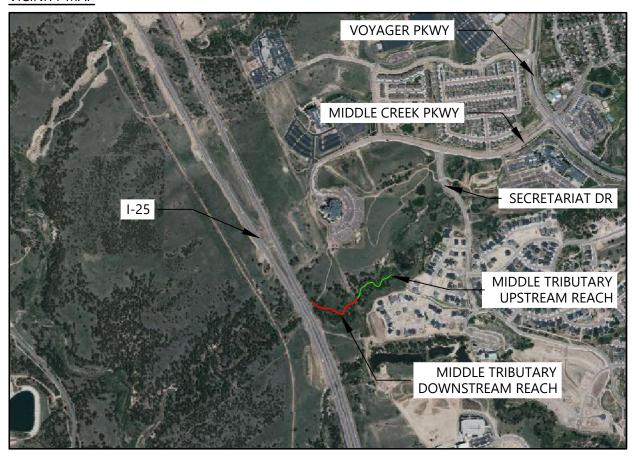



OWNER INFORMAITON

CITY OF COLORADO SPRINGS STORMWATER ENTERPRISE 30 S. NEVADA AVE, SUITE 401 COLORADO SPRINGS, CO 80903 719-385-5918





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Horizontal Scale & Orientation





SPRINGS



Client/Project

CITY OF COLORADO SPRINGS
MIDDLE TRIBUTARY UPSTREAM OF I-25
CHANNEL RESTORATION
COLORADO SPRINGS, CO

Project Milestone

100% DESIGN SUBMITTAL

Sheet Name COVER

2021013002

1" = 100'

t 1 of 66

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She

Sheet	List Table
Sheet Number	Sheet Title
1	COVER
2	TABLE OF CONTENTS
3	NOTES
4	NOTES (2)
5	NOTES (3)
6	NOTES (4)
7	SOAQ
8	GEOTECHNICAL BORING (1)
9	GEOTECHNICAL BORING (2)
10	GEOTECHNICAL BORING (3)
11	OVERVIEW
12	ACCESS (1)
13	ACCESS (2)
14	PLANVIEW (1)
15	PLANVIEW (2)
16	PLANVIEW (3)
17	UPSTREAM PLAN & PROFILE (1)
18	UPSTREAM PLAN & PROFILE (2)
19	UPSTREAM PLAN & PROFILE (3)
20	DOWNSTREAM PLAN & PROFILE (1)
21	DOWNSTREAM PLAN & PROFILE (2)
22	DOWNSTREAM PLAN & PROFILE (3)
23	BOULDER VANE 1
24	BOULDER VANE 2
25	BOULDER VANE 3
26	DROP STRUCTURE 1
27	DROP STRUCTURE 2
28	SHEET PILE 1
29	SHEET PILE 2
30	SHEET PILE 3
31	CONCRETE TRAIL
32	TYPICAL SECTION
33	COBBLE RIFFLE
34	BOULDER RIFFLE
35	SOIL LIFT WITH ROCK TOE

	_
36	RIPRAP BANK SECTION
37	RIFFLE SOIL LIFT SECTION
38	DROP STRUCTURE (1)
39	DROP STRUCTURE (2)
40	DROP STRUCTURE (3)
41	RIPRAP
42	SHEET PILE CAP
43	BOULDER RIFFLE SHEET PILE
44	REVEGETATION NOTES (1)
45	REVEGETATION NOTES (2)
46	REVEGETATION NOTES (3)
47	REVEGETATION NOTES (4)
48	REVEGETATION NOTES (5)
49	REVEGETATION NOTES (6)
50	REVEGETATION PLANTING PLAN (1)
51	REVEGETATION PLANTING PLAN (2)
52	REVEGETATION PLANTING PLAN (3)
53	REVEGETATION SEEDING PLAN (1)
54	REVEGETATION SEEDING PLAN (2)
55	REVEGETATION SEEDING PLAN (3)
56	SECTION SHEET - (1)
57	SECTION SHEET - (2)
58	SECTION SHEET - (3)
59	SECTION SHEET - (4)
60	SECTION SHEET - (5)
61	SECTION SHEET - (6)
62	SECTION SHEET - (7)
63	SECTION SHEET - (8)
64	SECTION SHEET - (9)
65	SECTION SHEET - (10)
66	SECTION SHEET - (11)





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STORMWATER

Client/Project

CITY OF COLORADO SPRINGS MIDDLE TRIBUTARY UPSTREAM OF I-25 CHANNEL RESTORATION COLORADO SPRINGS, CO

Project Milestone

100% DESIGN SUBMITTAL

Sheet Name

TABLE OF CONTENTS

2021013002 1" = 100'

GENERAL NOTES:

- 1. UNLESS OTHERWISE STATED, ALL COMPACTION SHALL BE PER SECTION 200 OF THE CITY SPECIFICATIONS.
- 2. ANY EXCAVATION SHALL BE DEWATERED TO THE EXTENT REQUIRED FOR CONSTRUCTION OPERATIONS TO PROCEED UNDER DRY CONDITIONS. DIKES, CHANNELS, FLUMES, DRAINS, SUMPS, PUMPING EQUIPMENT, AND OTHER TEMPORARY DIVERSION AND PROTECTIVE WORKS SHALL BE CONSTRUCTED, FURNISHED, INSTALLED, OPERATED, AND MAINTAINED BY THE CONTRACTOR AT NO ADDITIONAL COST TO THE OWNER. ALL COSTS TO OBTAIN REQUIRED DEWATERING AND DISCHARGE PERMITS SHALL BE INCLUDED IN THE WORK.
- WATER SHALL BE USED AS A DUST CONTROL WHERE REQUIRED. THIS WILL NOT BE PAID FOR SEPARATELY, BUT SHALL BE INCLUDED IN THE WORK.
- 4. UNDER NO CIRCUMSTANCES WILL ANY EXCESS MATERIAL BE DISPOSED OF IN WETLANDS OR WATERWAYS. REMOVED ASPHALT WILL NOT BE DISPOSED OF IN ANY MANNER THAT WOULD ALLOW THIS MATERIAL TO COME IN CONTACT WITH GROUND WATER. THE CONTRACTOR SHALL SUBMIT A DISPOSAL PLAN TO THE ENGINEER FOR APPROVAL.
- 5. THE CONTRACTOR SHALL LIMIT CONSTRUCTION ACTIVITIES TO THOSE AREAS WITHIN THE LIMITS OF DISTURBANCE AND TOES OF SLOPES AS SHOWN IN THE PLANS AND CROSS-SECTIONS. ANY DISTURBANCE BEYOND THESE LIMITS SHALL BE RESTORED TO THE ORIGINAL CONDITION AT THE CONTRACTOR'S EXPENSE. CONSTRUCTION ACTIVITIES, IN ADDITION TO THE NORMAL CONSTRUCTION PROCEDURES, SHALL INCLUDE VEHICLE AND EQUIPMENT PARKING, DISPOSAL OF LITTER, AND ANY OTHER ACTIVITY WHICH WOULD ALTER EXISTING CONDITIONS.
- 6. UNLESS OTHERWISE SPECIFIED, REMOVALS SHALL BECOME THE PROPERTY OF THE CONTRACTOR. REMOVALS SHALL BE DISPOSED OF OUTSIDE OF THE PROJECT LIMITS, UNLESS OTHERWISE APPROVED BY THE ENGINEER.
- 7. THE INFORMATION SHOWN ON THESE DRAWINGS CONCERNING TYPE AND LOCATION OF UNDERGROUND AND OTHER UTILITIES IS NOT GUARANTEED TO BE ACCURATE OR ALL INCLUSIVE. THE CONTRACTOR IS RESPONSIBLE FOR MAKING ALL DETERMINATIONS AS TO THE TYPE AND LOCATION OF UNDERGROUND AND OTHER UTILITIES AS MAY BE NECESSARY TO AVOID DAMAGE THERETO.
- 8. THE CONTRACTOR SHALL MAINTAIN DRAINAGE DURING CONSTRUCTION AS DIRECTED BY THE ENGINEER. THE REPAIR OF DAMAGES RESULTING FROM DRAINAGE AND RUNOFF IS SOLELY THE RESPONSIBILITY OF THE CONTRACTOR AND COST SHALL BE INCLUDED IN THE WORK.
- 9. THE CONTRACTOR IS RESPONSIBLE FOR THE PROTECTION OF THE WORK. ANY CONCRETE SUFFERING DAMAGE SUCH AS GRAFFITI, TACK COAT SPRAY, FOOTPRINTS, RAIN DAMAGE, ETC. WILL BE REMOVED AND REPLACED BY THE CONTRACTOR AT THE CONTRACTOR'S COST PRIOR TO FINAL ACCEPTANCE PAYMENT. IF ANY CONCRETE MUST BE REPLACED BECAUSE OF RAVELING AT THE JOINTS, RANDOM CRACKING, FOOTPRINTS, GRAFFITI, ETC. THE ENTIRE SLAB OR STONE MUST BE REPLACED AT THE CONTRACTOR'S EXPENSE.
- 10. THE CONTRACTOR SHALL PROTECT ALL EXISTING SURVEY MONUMENTATION DESIGNATED TO REMAIN FROM DAMAGE DURING CONSTRUCTION OPERATIONS. ANY MONUMENTS DISTURBED BY THE CONTRACTOR THAT ARE NOT DESIGNATED FOR RELOCATION SHALL BE RESET AT THE CONTRACTOR'S EXPENSE. THE CONTRACTOR AND ENGINEER SHALL NOTE THOSE MONUMENTS IN THE FIELD PRIOR TO CONSTRUCTION.
- 11. THE CONTRACTOR WILL BE RESPONSIBLE FOR PLACING TRAFFIC CONTROL DEVICES SO THAT THE WORK ZONES ARE IN FULL COMPLIANCE WITH THE MUTCD, AND CITY STANDARDS.
- 12. CONTRACTOR TO LOCATE ALL UTILITIES HORIZONTALLY AND VERTICALLY AND NOTIFY ENGINEER TO ADDRESS ANY CONFLICTS.
- 13. THE CONTRACTOR SHALL PROVIDE AND MAINTAIN DAILY ON-SITE GPS SURVEY CONTROL
- 14. BANKFULL CHANNEL EXTENTS SHOWN ON THE PLAN SHEETS ARE FOR GENERAL REPRESENTATION ONLY. BANKFULL CHANNEL SHALL BE CONSTRUCTED ACCORDING TO THE GRADING PLAN, CROSS-SECTION, AND PROFILE.
- 15. CONSTRUCTION TOLERANCES:
- 15.1. HORIZONTAL = PER PLAN
- 5.2. VERTICAL = 0.10 FEET (ALL STRUCTURES & WITHIN BANKFULL CHANNEL)
- 15.3. VERTICAL = 0.20 FEET (FLOODPLAIN GRADING)
- 16. DESIGN FLOWS:
- 16.1. RIFFLE SELECT MATERIAL DESIGNED FOR 10-YEAR EVENT (237 CFS)
- 6.2. BOULDER DROP STRUCTURE DESIGNED FOR 100-YEAR EVENT (792 CFS)
- 6.3. BOULDER VANE STRUCTURES DESIGNED FOR 100-YEAR EVENT (792 CFS)
- 17. CHANGES TO THESE DESIGN PLANS SHALL NOT BE ALLOWED UNLESS APPROVED IN WRITING BY THE DESIGN ENGINEER RESPONSIBLE FOR SIGNING AND SEALING THESE PLANS.



LEGEND:



BOULDER RIFFLE (SEE DETAIL)



BURIED BOULDER



EXPOSED BOULDER



SOIL RIPRAP



SOIL LIFT WITH ROCK TOE (SEE DETAIL)



RIFFLE (SEE DETAIL)



RIPRAP BANK (SEE DETAIL)



NEDIA KOIR MAT 900 EROSION CONTROL BLANKET

PMJM HIGH QUALITY HABITAT

PMJM UPLAND HABITAT

EXISTING SANITARY SEWER UTILITY

EXIG EXISTING GAS UTILITY


EXISTING ELECTRIC UTILITY

SHEET PILE

BANKFULL CHANNEL

EXISTING GROUND

PROPOSED THALWEG

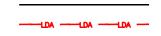

PROPOSED CONTOUR LIMITS OF DISTURBANCE

EXISTING CONTOUR

ACCESS CONTACTS:

ORACLE JOHN CORNELLA JOHN.CORNELLA@ORACLE.COM 719-491-3843

UTILITY CONTACTS:

CITY OF COLORADO SPRINGS TRAFFIC (FIBER OPTIC)	ROB HELT	719-385-7603
COLORADO SPRINGS UTILITIES (CSU)	JASON MESSAMER	719-668-4170
WATER AND WASTE WATER	AJ WERTZ	719-668-5586
GAS	TIM WENDT	719-668-4962
ELECTRIC	TIM WENDT	719-668-4962
USAFA	BRIAN MIHLBACHLER	719-333-3308



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CITY OF COLORADO SPRINGS MIDDLE TRIBUTARY UPSTREAM OF I-25 CHANNEL RESTORATION

COLORADO SPRINGS, CO

100% DESIGN SUBMITTAL

Project Milestone

100% DESIGN SOBIVITIE

Sheet Name
NOTES

2021013002 #######

Sheet 3 of 66

ORIGINAL SHEET - ANS

NOTES FOR WORK ON USAFA PROPERTY

LEGEND:	
	PMJM HIGH QUALITY HABITAT
	PMJM MEDIUM QUALITY HABITA
	PMJM UPLAND HABITAT

GENERAL NOTES: (Rev:2022MAY20)

- EXISTING UTILITY LINES ARE PRESENT IN THE PROJECT AREA, INCLUDING BUT NOT LIMITED TO: TELECOM, GAS, ELECTRIC, WATER, AND SANITARY SEWER. EXISTING UTILITIES HAVE NOT BEEN POTHOLED OR SURVEYED, AND HAVE BEEN SHOWN ON 6. THESE DRAWINGS BASED ON CAD INFORMATION PROVIDED BY USAFA. IT IS ASSUMED THAT UTILITIES EXIST IN THE PROJECT AREA IN ADDITION TO WHAT IS SHOWN. CONTRACTOR SHALL BE RESPONSIBLE FOR OBTAINING EXACT LOCATIONS AND ELEVATIONS OF ALL UTILITIES AND EQUIPMENT PRIOR TO EXCAVATION.
- CONTRACTOR SHALL OBTAIN AN APPROVED EXCAVATION PERMIT (AF FORM 103) FROM THE 10th CIVIL ENGINEER SQUADRON (CES) PRIOR TO ANY TRENCHING, EXCAVATION, OR EARTHWORK. URGENT REPAIR EXCAVATION PERMITS MUST BE REQUESTED BEFORE BEGINNING WORK. COORDINATE THE PERMIT REQUEST THROUGH THE 10 CES CONSTRUCTION MANAGER. COORDINATE WITH THE 10 CES CONSTRUCTION MANAGER TO SCHEDULE UTILITY LOCATES PRIOR TO DIGGING
- THE AREA OF WORK FOR THIS PROJECT IS SHOWN ON THE PLANS. CONTRACTOR IS TO LIMIT ALL CONSTRUCTION ACTIVITIES AND DISTURBANCES TO THIS AREA.
- IN THE EVENT THAT AN EXISTING UTILITY LINE IS DISCOVERED, AND IS NOT IDENTIFIED ON THE DRAWINGS, THE CONTRACTOR SHALL SURVEY THE SAID UTILITY AND NOTIFY THE GIS DEPARTMENT (719-459-4553) TO BE RECORDED INTO THE AFA GIS MAPPING SYSTEM.
- THE AIRFIELD MANAGER (AFM) WILL ESTABLISH HAUL ROUTES TO AND FROM THE CONSTRUCTION SITES. THE CONTRACTOR SHALL MAINTAIN ALL HAUL ROUTES CLEAR OF FOREIGN OBJECT DEBRIS (FOD) AT ALL TIMES. AT NO TIME WILL THE CONTRACTOR OPERATE OR PARK ANY EQUIPMENT ON THE ACTIVE AIRFIELD OPERATIONAL AREA. EQUIPMENT PARKING AND LAYDOWN AREA MUST BE APPROVED BY THE AFM.

- CONTRACTORS DRIVING ON THE AIRFIELD MUST BE CERTIFIED TO DRIVE ON THE AIRFIELD IN ACCORDANCE WITH THE LOCAL AIRFIELD DRIVING INSTRUCTION OR BE ESCORTED BY A QUALIFIED AIRFIELD DRIVER. CONTRACTORS WORKING WITHIN THE CONTROLLED AREA MUST COMPLETE APPROPRIATE TRAINING OR BE ESCORTED BY TRAINED PERSONNEL.
- THE CONTRACTOR SHALL MARK CLOSED TAXIWAYS/RUNWAYS IN ACCORDANCE WITH ETL 04-2, PARAGRAPH 9.2 AND UFC 3-260-01 REQUIREMENTS. THE AFM MUST APPROVE CLOSURE MARKINGS.
- 8. THE CONTRACTOR SHALL INSTALL LOW PROFILE BARRICADES TO MARK CLOSED AREAS AND OPEN TRENCHES. ALL BARRICADES MUST BE ILLUMINATED AT NIGHT AND MEET THE REQUIREMENTS OF ETL 04-2 AND UFC 3-260-01. THE AFM MUST APPROVE BARRICADE DESIGN AND LOCATIONS PRIOR TO IMPLEMENTATION.
- 9. THE CONTRACTOR AND AIRFIELD MANAGER (AFM) SHALL JOINTLY DEVELOP A PHASING PLAN THAT MINIMIZES IMPACT TO FLYING OPERATIONS. THIS MAY INCLUDE WEEKEND, NIGHT, OR HOLIDAY WORK. ADDITIONALLY, ANY CHANGES TO THE PHASING PLAN MUST BE APPROVED BY THE AFM.
- 10. ALL DISTURBED AREAS SHALL HAVE 3" OF TOPSOIL USAFA APPROVED SEED MIX. AND FOLLOW SPECIFICATIONS IN USAFA'S EROSION CONTROL, REVEGETATION AND TREE CARE STANDARDS.

FIRE PROTECTION NOTES:

- ANY WELDING, CUTTING, BRAZING, SOLDERING OR OPEN FLAME MUST HAVE A BURN PERMIT ISSUED FOR THE SPECIFIC WORK AREA WHICH WORK IS TO BE PERFORMED. CONTACT PERSONNEL AT FIRE STATION #3 AT 719-333-4433.
- FIRE EXTINGUISHERS MUST BE KEPT ON HAND AROUND HEAT PRODUCING EQUIPMENT AT ALL TIMES.
- FLAMMABLE AND COMBUSTIBLE MATERIAL MUST BE STORED SAFELY WHEN NOT IN USE AND DURING OPEN FLAME OPERATIONS.
- WORK SITE MUST BE KEPT NEAT, ALL DEBRIS HAULED AWAY FROM THE SITE ON A DAILY BASIS OR MORE FREQUENTLY AS NEEDED.
- SMOKING IS NOT ALLOWED IN OR AROUND THE WORK SITE. COORDINATE A DESIGNATED SMOKING AREA AS
- ALL EMERGENCY REPORTING ON THE ACADEMY: DIAL 911.
- CONTACT 719-333-2051 FOR ASSISTANCE.



ADDITIONAL NOTES:

- USAFA UTILITY LOCATE REQUESTS AND DIG PERMITS MUST BE COORDINATED WITH 10 CES/PRODUCTION CONTROL AT (719) 333-2790.
- SHOULD ANY POTENTIAL CULTURAL MATERIALS BE ENCOUNTERED (BONES, POTTERY, GLASS, METAL ITEMS, ETC.), THE CONTRACTOR AND USAFA WILL FOLLOW THE STANDARD OPERATING PROCEDURES FOR DISCOVERIES OF ARCHEOLOGICAL RESOURCES AND NAGPRA ITEMS AS PUBLISHED IN THE 2019 INTEGRATED CULTURAL RESOURCES MANAGEMENT PLAN. ALL WORK SHOULD STOP, AND IMMEDIATELY CONTACT THE USAFA CULTURAL RESOURCES MANAGER, ERWIN ROEMER, AT (719) 333-7341 OR ERWIN.ROEMER@US.AF.MIL
- WORK IS OCCURRING WITH THE HABITAT OF THE FEDERALLY-THREATENED PREBLE'S MEADOW JUMPING MOUSE. TO PREVENT INADVERTENT IMPACTS TO HABITAT OR THE MOUSE, THE CONTRACTOR SHALL
- RECEIVE A BRIEFING FROM USAFA NATURAL RESOURCES AT THE PRE-CONSTRUCTION KICK-OFF MEETING 3.1.
- BE SUPERVISED BY USAFA NATURAL RESOURCES DURING CONSTRUCTION 3.2.
- 3.3. FENCE OR OTHERWISE DELINEATE THE APPROVED LIMITS OF DISTURBANCE
- CONTACT USAFA NATURAL RESOURCES AT (719) 333-3308 IF A DEAD, INJURED, OR HIBERNATING MOUSE IS 34 ENCOUNTERED DURING CONSTRUCTION.



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CITY OF COLORADO SPRINGS MIDDLE TRIBUTARY UPSTREAM OF I-25 **CHANNEL RESTORATION** COLORADO SPRINGS, CO

Project Milestone

100% DESIGN SUBMITTAL

Sheet Name

USAFA NOTES

2021013002

1" = 100'

Sheet 4 of 66

NOTES FOR WORK ON USAFA PROPERTY

ENVIRONMENTAL NOTES: (Rev:2020JULY06)

- THE CONTRACTOR SHALL HEED THE USAFA ENVIRONMENTAL STANDARDS. CONTACT 10 CES/CEIEC AT 719.333.5826 FOR THE MOST CURRENT VERSION.
- GREEN PROCUREMENT THE CONTRACTOR, 10 DAYS PRIOR TO CONSTRUCTION START, SHALL SUBMIT A GREEN
 PROCUREMENT PROGRAM (GPP) REPORT TO THE 10 CES/CEIEC GPP MANAGER AT 719.333.5826. THE CONTRACTOR
 SHALL COMPLY WITH THE EPA'S COMPREHENSIVE PROCUREMENT GUIDELINES REGARDING THE PURCHASE OF EPA
 DESIGNATED PRODUCTS.
- SOLID WASTE THE CONTRACTOR, ON A MONTHLY BASIS AND WITHIN 10 DAYS FROM PROJECT COMPLETION, SHALL SUBMIT A SOLID WASTE REPORT TO THE 10 CES/CEIEC SOLID WASTE MANAGER AT 719.333.5826. THE REPORT MUST INCLUDE WEIGHT CONSTRUCTION DEBRIS DISPOSED AND RECYCLED, ITEMIZED.
- AIR QUALITY CONTRACTORS SHALL REMAIN IN COMPLIANCE WITH ALL FEDERAL, STATE, LOCAL, DOD AND AIR
 FORCE AIR QUALITY REQUIREMENTS. CONTRACTORS SHALL FULLY COMPLY WITH THE CONDITIONS OF ALL
 APPLICABLE COLORADO AIR POLLUTION PREVENTION AND CONTROL ACT AND REGULATIONS AS IDENTIFIED IN 5
 CCR 1001: REGULATIONS 1-19.

FOR PROJECTS DISTURBING MORE THAN ONE ACRE, BUT LESS THAN 25 ACRES, FOR LESS THAN SIX MONTHS DURATION, CONTRACTORS SHALL SUBMIT A PERMIT APPLICATION TO EL PASO COUNTY WITH COPIES SUBMITTED TO 10 CES/CEIEC. FOR PROJECTS DISTURBING MORE THAN 25 ACRES, OR DISTURBING AN AREA OF ANY SIZE FOR A DURATION LONGER THAN SIX MONTHS, THE CONTRACTOR SHALL SUBMIT AN AIR POLLUTION EMISSION NOTICE (APEN) ALONG WITH ASSOCIATED FEES TO THE STATE. A COPY OF THE APEN WILL BE SUBMITTED TO 10 CES/CEIEC, AIR QUALITY MANAGER AT 719.333.5826.

ANY EQUIPMENT OR ACTIVITY THAT EMITS OR HAS THE POTENTIAL TO EMIT POLLUTANTS OR THAT DISTURBS SOLID OR LIQUID MATERIALS, WHICH CAN BECOME AIRBORNE, IS A SOURCE OF AIR POLLUTION THAT MAY REQUIRE A PERMIT. ACTIVITIES WITH ANTICIPATED AIR EMISSIONS INCLUDE BUT ARE NOT LIMITED TO PAINTING, STRIPPING, CLEANING WITH DEGREASERS OR SOLVENTS, MATERIAL HAULING, DEMOLITION, SAND BLASTING, USE OF FUEL-BURNING EQUIPMENT (OTHER THAN MOTOR VEHICLES), WELDING, USE OF VOLATILE ORGANIC COMPOUNDS OR OZONE-DEPLETING CHEMICALS (ODCS), AND REMEDIATION ACTIVITIES. CONTRACTORS SHALL OBTAIN APPROVAL FOR USE OF HAZARDOUS MATERIALS AS IDENTIFIED IN ITEM 5 HAZARDOUS MATERIALS.

IF AIR EMISSION ESTIMATES FOR CRITERIA OR HAZARDOUS AIR POLLUTANTS (HAPS) EXCEEDS THRESHOLD LEVELS (AS DEFINED BY 5 CCR 1001-5: REGULATION NO. 3) THE CONTRACTOR SHALL COMPLETE AN APEN AND/OR CONSTRUCTION PERMIT APPLICATIONS REQUIRED BY CDPHE, AIR POLLUTION CONTROL DIVISION (APCD). CONTRACTORS SHALL SUBMIT THE COMPLETED APEN(S) AND/OR CONSTRUCTION PERMIT APPLICATION(S) TO CDPHE AND PROVIDE A COPY TO 10 CES/CEIEC, AIR QUALITY MANAGER AT 719.333.5826.

CONTRACTORS SHALL ENSURE ALL COMPANY-OWNED AND EMPLOYEE OWNED GASOLINE AND DIESEL VEHICLES WHICH SHALL BE DRIVEN ON USAFA COMPLY WITH THE EMISSIONS INSPECTION REQUIREMENTS OF CDPHE 5 CCR 1001-13: REGULATION NO. 11 (MOTOR VEHICLE EMISSIONS INSPECTION PROGRAM) AND 5 CCR 1001-15: REGULATION NO. 12 (REDUCTION OF DIESEL VEHICLE EMISSIONS).

OPEN BURNING ON USAFA IS PROHIBITED.

CONTRACTORS SHALL CREATE NO NOXIOUS ODORS THAT VIOLATE COLORADO'S ODOR EMISSIONS REGULATION (5 CCR 1001-4: REGULATION NO. 2).

CONTRACTORS SHALL ENSURE ANY EQUIPMENT CONTAINING OZONE-DEPLETING COMPOUNDS (ODC) ARE OPERATED AND MAINTAINED IN ACCORDANCE WITH COLORADO'S CONTROL OF EMISSION OF (ODC) REQUIREMENTS (5 CCR 1001-19: REGULATION NO.15). ALL CONTRACTORS AND SUBCONTRACTOR EMPLOYEES SERVICING ODC CONTAINING EQUIPMENT SHALL BE TRAINED AND EPA CERTIFIED IN ACCORDANCE WITH COPHE AIR QUALITY REGULATION NO. 15. CONTRACTORS MUST SUBMIT COPIES OF TECHNICIAN AND EQUIPMENT CERTIFICATIONS TO 10 CES/CEIEC PRIOR TO START OF WORK AT 719.333.5826. ALL CLASS I ODC USE IS PROHIBITED. ANY REQUESTS FOR USE OF CLASS II ODC MUST BE SUBMITTED IN WRITING TO THE CO FOR REVIEW AND APPROVAL. OTHERWISE. THE USE OF CLASS II ODS IS PROHIBITED.

CONTRACTORS SHALL TAKE ACTIVE STEPS TO PREVENT EVAPORATION OF ALL SOLID OR LIQUID MATERIALS THAT HAVE POTENTIAL TO BECOME AIRBORNE INCLUDING BUT NOT LIMITED TO FUELS, SOLVENTS, PAINTS, AND OTHER VOLATILE CHEMICALS UNDER THE CONTRACTOR'S CONTROL. ALL CONTAINERS HOLDING SOLID OR LIQUID MATERIALS THAT HAVE POTENTIAL TO BECOME AIRBORNE SHALL BE CLOSED AT ALL TIMES.

WHEN A FUGITIVE PARTICULATE CONTROL PLAN IS NOT REQUIRED BY 5 CCR 1001-3: REGULATION NO. 1, CONTRACTORS SHALL PERFORM ALL FUGITIVE PARTICULATE CONTROL MEASURES NECESSARY TO PREVENT EMISSIONS OF OVER 20 PERCENT OPACITY OR VISIBLE EMISSIONS THAT CROSS USAFA'S PROPERTY BOUNDARIES. CONTRACTORS SHALL MAINTAIN A DAILY LOG OF FUGITIVE PARTICULATE EMISSIONS THAT EXCEED 20 PERCENT OPACITY OR THAT CAUSE VISIBLE EMISSIONS. CONTRACTORS SHALL MAINTAIN A COPY OF THIS LOG ON SITE AT ALL TIMES AND SHALL MAKE IT AVAILABLE FOR REVIEW BY 10 CES/CEIEC, AIR QUALITY MANAGER UPON REQUEST.

CONTRACTORS SHALL NOT UTILIZE CUTBACK ASPHALT OR ANY COATING INCLUDED IN THE DEFINITION OF CUTBACK ASPHALT AS DEFINED AT 5 CCR 1001-9: REGULATION NO. 7 DURING THE MONTHS OF MARCH THROUGH SEPTEMBER UNLESS THE CUTBACK ASPHALT IS USED SOLELY AS A PENETRATING PRIME COAT; OR IF THE USER CAN DEMONSTRATE TO CDPHE APCD THAT UNDER THE CONDITIONS OF ITS INTENDED USE THAT THERE WILL BE NO EMISSIONS OF VOLATILE ORGANIC COMPOUNDS TO THE AMBIENT AIR. ALL INFORMATION CONCERNING SUCH WILL BE SENT TO 10 CES/CEIEC, AIR QUALITY MANAGER AT 719.333.5826.

CONTRACTORS SHALL NOT APPLY SAND OR GRAVEL TO USAFA ROADS WITHOUT OBTAINING PRIOR WRITTEN APPROVAL FROM 10 CES/CEIEC, AIR QUALITY MANAGER 719.333.5826.

CONTRACTORS SHALL PROPERLY RE-VEGETATE ALL DISTURBED LAND TO PREVENT FUGITIVE PARTICULATE EMISSIONS FOLLOWING THE COMPLETION OF WORK.

WATER QUALITY - CONSTRUCTION STORM WATER, IF GREATER THAN OR EQUAL TO ONE (1) ACRE OF LAND DISTURBANCE IS CREATED. A STORM WATER CONSTRUCTION ELECTRONIC NOTICE OF INTENT (ENOI) IS REQUIRED TO BE FILED BY THE CONTRACTOR. IF AN ENOI IS REQUIRED, THE CONTRACTOR IS REQUIRED TO PREPARE A STORM WATER POLLUTION PREVENTION PLAN (SWPPP) PRIOR TO SUBMITTING THE ENOI. THE SWPPP SHALL COMPLY WITH ALL PROVISIONS OF THE NATIONAL POLLUTANT DISCHARGE ELIMINATION SYSTEM (NPDES) GENERAL PERMIT FOR DISCHARGES FROM CONSTRUCTION ATIVITIES, GENERAL PERMIT NO. COR12000F. PLEASE REFER TO THE USAFA AND CONTRACTOR STORM WATER PERMITTING GUIDANCE DOCUMENT FOR INSTRUCTION. THE SWPPP MUST BE APPROVED BY THE 10 CES/CEIEC WATER QUALITY MANAGER PRIOR TO ENOI FILING. THE ENOI REQUIRES INFORMATION PROVIDED BY 10 CES/CEIEC TO THE CONTRACTOR. A COPY OF THE APPROVED, FINAL AND SIGNED SWPPP SHALL BE PROVIDED TO THE 10 CES/CEIEC WATER QUALITY MANAGER. THE STORM WATER PERMITTING PROCESS IS REQUIRED TO BE COMPLETED PRIOR TO CONSTRUCTION COMMENCEMENT. THE EPA ENOI APPROVAL PROCESS IS, AT A MINIMUM, A 14-DAY PROCESS AND WORK CANNOT BEGIN UNTIL FINAL APPROVAL IS RECEIVED. CONTRACTORS ARE URGED TO SUBMIT THE SWPPP TO THE USAFA CONTRACTING OFFICE OR 10 CES/CEIEC 30 DAYS PRIOR TO GROUND-BREAKING.

IF INITIALLY THE CONTRACTOR DETERMINES THAT LESS THAN ONE (1) ACRE IS PROPOSED TO BE DISTURBED, AND THE DISTURBANCE IS ACTUALLY GREATER THAN OR EQUAL TO ONE (1) ACRE DURING CONSTRUCTION, THE PROCESS NOTED IN THE ABOVE PARAGRAPH MUST BE COMPLETED IMMEDIATELY. THE PROJECT MAY BE TEMPORARILY HALTED UNTIL THE CONTRACTOR AND USAFA SECURE THE STORM WATER PERMIT COVERAGE. IF THE CONTRACTOR EQUALS OR EXCEEDS THE ONE (1) ACRE DISTURBANCE THRESHOLD DURING CONSTRUCTION WITHOUT REGULATORY AUTHORIZATION, THE CONTRACTOR IS RESPONSIBLE FOR ANY PROJECT DELAY COSTS. UPON PROJECT COMPLETION, AN ELECTRONIC NOTICE OF TERMINATION (ENOT) WITH THE STORM WATER GENERAL PERMIT IS REQUIRED TO BE FILED. THE ENOT IS REQUIRED TO BE APPROVED BY THE 10 CES/CEIEC WATER QUALITY MANAGER.

LAND DISTURBANCE INCLUDES GRUBBING, CLEARING, EXCAVATION, GRADING, STOCKPILING, MAINTENANCE YARDS, AND OTHER AREAS CREATING GROUND DISRUPTION IN WHERE VEGETATION IS REMOVED OR SIGNIFICANTLY IMPACTED. IF PROPOSED LAND DISTURBANCE IS LESS THAN ONE (1) ACRE, THE CONTRACTOR IS REQUIRED TO IMPLEMENT STORM WATER BEST MANAGEMENT PRACTICES (BMPS) WITHOUT FILING AN ENOI AND RELATED SWPPP. REFER TO THE 10 CES/CEIEC ENVIRONMENTAL STANDARDS FOR MORE GUIDANCE. PLEASE CONTACT THE 10 CES/CEIEC WATER QUALITY MANAGER AT 719-459-4548 TO DISCUSS STORM WATER PERMITTING REQUIREMENTS.

70% VEGETATIVE COVER IS REQUIRED TO BE ESTABLISHED BEFORE A NOT CAN BE APPROVED BY WATER QUALITY MANAGER.

REFERENCE UNITED STATES AIR FORCE ACADEMY STANDARD SECTION 01351

IF THE PROPOSED ACTIVITIES IMPACT WATERS OF THE US BY FILLING ACTIVITY, NATIONWIDE AUTHORIZATION OR AN INDIVIDUAL PERMIT IS REQUIRED TO BE APPROVED BY THE US ARMY CORPS OF ENGINEERS (USACE). UPON ADEQUATE PROJECT DESCRIPTION, THE 10 CES/CEIEC WATER QUALITY MANAGER OR CONTRACTOR WILL PREPARE AND SUBMIT THE APPROPRIATE USACE AUTHORIZATION/PERMITTING APPLICATIONS. THE PERMIT APPLICATION IS REQUIRED PRIOR TO START OF CONSTRUCTION. ANY QUESTIONS REGARDING WHAT CONSTITUTES "WATERS OF THE US," SHALL BE DIRECTED TO THE 10 CES/CEIEC WATER QUALITY MANAGER.

IF WASTE WATER IS GENERATED BY THE PROJECT OR CONSTRUCTION ACTIVITY, THE 10 CES/CEIEC WATER QUALITY MANAGER SHALL BE NOTIFIED PRIOR TO DISPOSAL OR DISCHARGE. NON-STORM WATER DISCHARGES ARE PROHIBITED FROM BEING DISCHARGED TO THE USAFA STORM WATER SYSTEM. DISCHARGES TO THE USAFA WASTE WATER TREATMENT PLANT (WWTP) REQUIRE PRE-AUTHORIZATION BY 10 CES/CEIEC AND/OR THE WWTP MANAGER. PLEASE CONTACT THE 10 CES/CEIEC WATER QUALITY MANAGER IF THE PROJECT GENERATES WASTE WATER.

HAZARDOUS WASTE - IF HAZARDOUS WASTES ARE TO BE GENERATED BY CONSTRUCTION, THE 10 CES/CEIEC HAZARDOUS WASTE MANAGER SHALL BE CONTACTED AT 719.333.5826 PRIOR TO GENERATION.

THE CONTRACTOR SHALL OBTAIN APPROVAL FOR A WRITTEN SPILL PREVENTION RELEASE PLAN (SPRP) PRIOR TO CONSTRUCTION START. PLAN SHALL BE SUBMITTED TO THE 10 CES/CEIEC HAZARDOUS MATERIAL AND HAZARDOUS WASTE MANAGER AT 719.333.5826.

- SPILL PREVENTION CONTROLS AND COUNTERMEASURES (SPCC) ANY CONTRACTOR STORING OIL, AS DEFINED BY 40 CFR 112.2, IN CONTAINERS WITH A CAPACITY OF 55 GALLONS OR MORE, SHALL SUBMIT AN INVENTORY OF THE CONTAINERS FOR APPROVAL TO THE 10 CES/CEIEC POLS MANAGER AT 719.333.6425. IF A CONTRACTOR'S AGGREGATE OIL STORAGE CAPACITY IS 1,320 GALLONS OR GREATER, AN SPCC PLAN SHALL BE PREPARED ACCORDING TO THE REQUIREMENTS OF 40 CFR 112 AND A COPY SHALL BE PROVIDED TO THE SPCC COORDINATOR.
- STORAGE TANKS NO CONTRACTOR IS AUTHORIZED TO USE OR STORE STORAGE TANKS ON USAFA WITHOUT PERMISSION FROM USAFA. PLEASE CONTACT 10 CES/CEIEC AT 719.333.5826 IF THE PROJECT REQUIRES THE USE OF STORAGE TANKS.
- PERMITTING ALL REGULATORY PERMITTING AND AUTHORIZATION ASSUMPTIONS ARE BASED ON DETAILS PROVIDED IN THE DESIGN ANALYSIS DOCUMENTS AND DRAWINGS SUBMITTED. ANY FIELD CHANGES IN PROJECT SCOPE, DESIGN, OR CONSTRUCTION EXECUTION MAY REQUIRE ADDITIONAL REGULATORY PERMITTING OR AUTHORIZATIONS. PLEASE CONTACT 10 CES/CEIEC IMMEDIATELY IF CHANGES TO THE PROJECT ARE IMPLEMENTED.





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CITY OF COLORADO SPRINGS
MIDDLE TRIBUTARY UPSTREAM OF I-25
CHANNEL RESTORATION
COLORADO SPRINGS, CO

Project Milestone

100% DESIGN SUBMITTAL

Sheet Name

USAFA NOTES (2)

2021013002

1" = 100'

Sheet 5 of 66

GEOTECHNICAL NOTES:

- 1. SUBGRADE SHALL BE PREPARED BY SCARIFYING THE SUBGRADE SOILS TO A DEPTH OF AT LEAST 8 INCHES, MOISTURE CONDITIONING AND COMPACTING AS RECOMMENDED.
- 2. IF BEDROCK IS EXPOSED AT THE PLANNED EXCAVATION ELEVATION, IT SHOULD BE SCRAPED CLEAN AND RELATIVELY FLAT.
- 3. ALL FILL MATERIAL SHALL BE PLACED ON A HORIZONTAL PLAN AND PLACED IN LOOSE LIFTS NOT TO EXCEED 8 INCHES OF THICKNESS.
- 4. ZONES OF VERY MOIST TO WET, SOFT, UNSTABLE SOILS MAY BE ENCOUNTERED DURING EXCAVATION. IF ENCOUNTERED AT THE PLANNED EXCAVATION ELEVATION, IT SHOULD BE SCARAFIED, RECOMPACTED AND PROOF-ROLLED PRIOR TO PLACEMENT OF FILL. USE OF ROCK, OR A COMBINATION OF GEO-GRID AND AGGREGATE, CAN BE USED TO STABILIZE AREAS THAT CANNOT OTHERWISE BE PROPERLY PREPARED FOR SUPPORT OF ADDITIONAL FILL OR STRUCTURAL ELEMENTS.
- FILL MATERIALS
- 5.1. STRUCTURAL FILL: THIS MATERIAL SHALL BE PLACED BELOW ANY FOUNDATION OR DROP STRUCTURE ELEMENTS IF SANDSTONE/CLAYSTONE BEDROCK IS NOT ENCOUNTERED AT SUBGRADE ELEVATIONS AND SHOULD INCLUDE IMPORTED GRANULAR MATERIAL MEETING THE REQUIREMENTS OF (CDOT) CLASS 1 STRUCTURE BACKFILL. ON-SITE SANDS MAY BE RE-USED AS STRUCTURAL BACKFILL.
- 5.2. COMMON FILL: COMMON FILL MUST BE PROPERLY PREPARED AND PLACED AT A DEPTH THAT WILL NOT BE EXPOSED TO STREAM FLOW/EROSIVE HYDRAULIC FORCES. WET ON-SITE SOILS WILL NEED TO BE DRIED TO WITHIN THE COMPACTION MOISTURE CRITERIA PRIOR TO RE-COMPACTION.
- 5.3. STREAMBED FILL: SEE ENGINEERING PLANS.
- 6. SEE TABLE 2 FOR COMPACTION CRITERIA.
- 7. FILL SHOULD BE PLACED IN LEVEL LIFTS NOT EXCEEDING 8 INCHES IN LOOSE THICKNESS AND COMPACTED TO THE SPECIFIED PERCENT COMPACTION TO PRODUCE A FIRM AND STABLE SURFACE.
- 8. FOR DROP STRUCTURES AND BOULDER RIFFLES BEAR DIRECTLY ON OR WITHIN THE SANDSTONE/CLAYSTONE BEDROCK OR ON AT LEAST 12 INCHES OF PROPERLY COMPACTED GRANULAR STRUCTURAL FILL. IF OVER-EXCAVATION OF THE SOILS IS REQUIRED, THE EXCAVATION SHOULD EXTEND LATERALLY AT LEAST 18 INCHES BEYOND THE EDGE OF THE FOUNDATION ELEMENT.
- 9. IT IS ANTICIPATED THAT SHEET PILING CANNOT BE DRIVEN TO SIGNIFICANT DEPTHS INTO THE BEDROCK. PENETRATION OF NO MORE THAN 12 TO 18 INCHES IS EXPECTED BEFORE REFUSAL OCCURS IN SOME AREAS WITHIN THE CHANNEL. IT MAY BE POSSIBLE TO PRE-DRILL HOLES OR TRENCH INTO THE BEDROCK TO EASE THE INSTALLATION OF SHEET PILING. IF THIS CONDITION OCCURS, CONCRETE SHOULD BE USED TO FILL THE TRENCH AROUND THE SHEET PILE.
- 10. ONCE BEDROCK IS ENCOUNTERED, SHEET PILING SHALL BE DRIVEN TO "SEAT" THE SHEET PILING INTO THE BEDROCK. ATTEMPTING TO DRIVE THE SHEET PILING TO ACHIEVE DEEPER PENETRATION IS LIKELY TO DAMAGE THE SHEET PILE.

Table 2 Compaction Specifications

FILL LOCATION	MATERIAL TYPE (See Section 4.2.4)	PERCENT COMPACTION ¹ (ASTM D1557)	MOISTURE CONTENT
Subgrade Preparation (after clearing, grubbing, excavation, and prior to placement of new fill and/or structural elements)	On-site soils	92 minimum -or- stabilized per Section 4.2.2	± 2 % of optimum
Drop Structure and Wall Foundation Subgrade (if not bearing on bedrock)	CDOT Class I Structure Backfill	92 minimum	± 2 % of optimum
Structural Fill			
Utility Trench Backfill (if applicable)	On-site Soils	90 minimum	± 2 % of optimum
Potential Slope Re-Grading/ Embankment Fill	On-site Soils	92 minimum	± 2 % of optimum
Lower Zone of Channel Backfill ("Common Fill")	On-site Sand or Clay Soils	90 minimum	± 2 % of optimum
Streambed Fill	Materials Defined by Hydraulic Engineer	90 minimum	± 2 % of optimum

The more stringent compaction criteria should be utilized where two or more "fill locations" coincide. In nonstructural/landscaped areas, the compaction specification may be reduced to 90 percent.





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CITY OF COLORADO SPRINGS
MIDDLE TRIBUTARY UPSTREAM OF I-25
CHANNEL RESTORATION
COLORADO SPRINGS, CO

STORMWATER

Project Milestone

100% DESIGN SUBMITTAL

Sheet Name

GEOTECHNICAL NOTES

2021013002 Project No. 1" = 100'

.



SUMMARY OF APPROXIMATE QUANTITIES

DESCRIPTION	UNIT	QTY
MOBILIZATION	LS	
CONSTRUCTION SURVEYING	LS	
REDLINE DRAWINGS	LS	
EROSION AND SEDIMENT CONTROL	LS	
WATER CONTROL AND DEWATERING	LS	
WORK ZONE TRAFFIC CONTROL	LS	
CLEARING AND GRUBBING	LS	
SITE RESTORATION	LS	
CONSTRUCTION FENCING	LF	6712
EARTHWORK - ONSITE	СҮ	70
EARTHWORK - IMPORT	CY	714
TOPSOIL	CY	51
CONCRETE TRAIL (5 INCH)	SY	21
CONCRETE CURB (6 INCH)	LF	26
REINFORCING STEEL	LB	26
SHEET PILE WALL	SY	254
SHEET PILE CAP	LF	342
SELECT MATERIAL	CY	271
SOIL-FILLED RIPRAP (18 INCH)	CY	485
VOID-FILLED RIPRAP (12 INCH)	CY	18
RIFFLE BOULDERS (24 INCH)	EA	60
VANE BOULDERS (24 INCH)	LF	409
GROUTED BOULDERS (24 INCH)	LF	340
GROUTED BOULDERS (36 INCH)	SY	89
GROUTED BOULDERS (42 INCH)	SY	69
NEDIA KOIRMAT 900	SY	757
NEDIA KOIRMAT 1200	SY	481
WILLOW STAKE	EA	6192
HERBACEAUS PLUG (10CI)	EA	12750
SHRUB (60 CI)	EA	575
TREE (5-GALLON)	EA	50
WETLAND AND RIPARIAN SEED (ZONE A, B, C)	AC	0.8
UPLAND SEED (ZONE D)	AC	2.3
BIOSOL SOIL AMENDMENT (ZONE B, C, & D)	AC	2.4
HYDROMULCH AND TACKIFER (ZONE B, C, & D)	AC	2.4
TEMPORARY SEEDING, TOPSOIL STOCKPILE	AC	1.0





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Project Milestone


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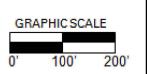
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REFERENCE:

Base image obtained from Google Earth Pro Dated: 10/6/2019

LEGEND





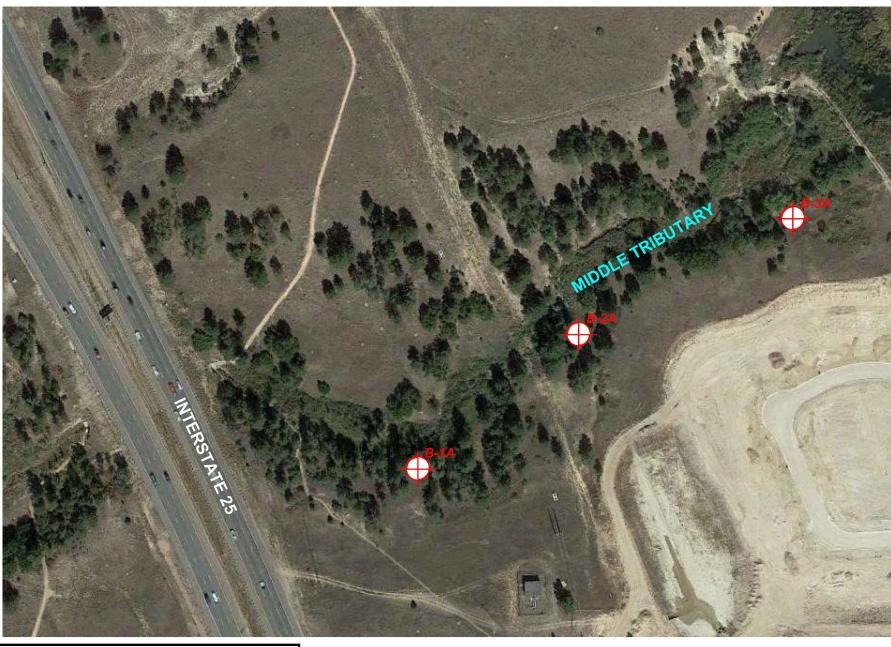

VIVID Engineering Group, Inc. 1053 Elkton Drive Colorado Springs, CO 80907 719-896-4356 Project No.D21-2-470

Date: February 21, 2022

Drawn by: BTM

Reviewed by: WJB

FIELD EXPLORATION PLAN

Proposed Middle Tributary Improvements East of I-25 and West of Secretariat Drive Colorado Springs, Colorado FIGURE

2



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Project Milestone

100% DESIGN SUBMITTAL

Sheet Name

GEOTECHNICAL BORING (1)

2021013002

1" = 100"

. . . .

Sheet 8 of 66

RIGINAL SHEET - ANSLB

Engineering Group Engineering Group Fax CLIENT WaterVatio PROJECT NUMBER DATE STARTED 1/1 DRILLING CONTRAC DRILLING METHOD	D21-2-470 14/22 COMP L	ETED 1/14/22	PROJECT LOCATION Colorado Springs, Colorado GROUND ELEVATION 6587.244 ft HOLE SIZE 4 inches GROUND WATER LEVELS:
SAMPLE TYPE NUMBER BLOW COINTS	TESTS	GRAPHIC LOG	MATERIAL DESCRIPTION
GB 5 MC 10- 10 MC 33-5 15 MC 50/3"	mg/kg, Chloride = 158 mg/kg, Sulfate = 0.0546% MC = 11.3% DD = 118.4 pcf LL = NP PL = NP Fines = 20.0%	↓ ↓ ↓ ↓ ↓ ↓ ↓ ↓ ↓ ↓ ↓ ↓ ↓ ↓ ↓ ↓ ↓ ↓ ↓	CLAYSTONE, light gray to bluish-gray, moist, moderately hard 6577.7
			BID SE

Engle	IVID neering Group	1053 Elk Colorado Telephor	ngineering Group, Inton Drive on Springs, Colorado ne: 719-896-4356 9-896-4357			BORING NUMBER B PAGE 1	
CLIEN	IT Wate	rVation				PROJECT NAME Proposed Middle Tributary Channel Improvements	1
			-2-470			PROJECT LOCATION Colorado Springs, Colorado	
					1/14/22		
NOTE		м. кау	CHEC	KED B	Y B. Mustain	AT END OF DRILLING AFTER DRILLING	
NOTE						AFTER DRILLING	
o DEPTH (ft)	SAMPLE TYPE NUMBER	BLOW COUNTS (N VALUE)	TESTS	GRAPHIC LOG		MATERIAL DESCRIPTION	
 	∰ GB				Clayey SANI	D, fine to medium-grained, light brown, slightly moist, medium dense	
5	МС	6-6	MC = 4.4%				
							001
					Poorly Grade	d SAND, fine to coarse-grained, light gray, moist, medium dense	
10	мс	8-9					
_							
					13.5		65
	MC MC	50/7"	MC = 15.5%	********	Dawson For		
15	IVIO	30/1	DD = 113.0 pcf UCS = 3,398		hard	SANDSTONE and CLAYSTONE, yellowish-brown, bluish-gray, moist,	
			PSF, Shear				
			Strength = 1,699 PSF		$\bar{\Delta}$		
				· · · ·			
 20	МС	50/10"		l l			
_]							
		50.7"	MO = 10.70/	• • •			
	★ MC	50/7"	MC = 13.7% DD = 123.0 pcf		24.6	Bottom of borehole at 24.6 feet.	65
			LL = 36 PL = 27				
			Fines = 40.0%				



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CITY OF COLORADO SPRINGS MIDDLE TRIBUTARY UPSTREAM OF I-25 CHANNEL RESTORATION COLORADO SPRINGS, CO

Project Milestone

100% DESIGN SUBMITTAL

Sheet Name

GEOTECHNICAL BORING (2)

2021013002 1" = 100' Project No.

Sheet 9 of 66

'RY_GE						
2021/021-2-470_WATERVATION_MIDDLE TRIBUTARY_GEG CORP CORP CORP. CORP CORP. CORP CORP. CORP CORP. C	VIV	(ID)	1053 Elkt Colorado Telephon	gineering Group, Ir ton Drive Springs, Colorado e: 719-896-4356 -896-4357		BORING NUMBER B-3A PAGE 1 OF 2
E CLIE	NT _	Water	Vation			PROJECT NAME Proposed Middle Tributary Channel Improvements
∯ PRO	JECT	NUM	BER D21	-2-470		PROJECT LOCATION Colorado Springs, Colorado
DATE						D 1/14/22 GROUND ELEVATION 6623.176 ft HOLE SIZE 4 inches
DRIL						GROUND WATER LEVELS: AT TIME OF DRILLING
LOG						BY B. Mustain AT END OF DRILLING
္က ဗူ						AFTER DRILLING
276222 15-19- C: USERS/BRYSEN MUSTAINWVID ENGINEERING GROUP/GEOTECH GROUP VIVID ENGINEERING - DOCUMENTS/PROJECTS. O DEPTH (f)	SAMPLE TYPE	NUMBER	BLOW COUNTS (N VALUE)	TESTS	GRAPHIC LOG	MATERIAL DESCRIPTION
/IVID ENGINEERING	-	GB				Sandy Lean CLAY, light brown, slightly moist, medium stiff
6 5 5	H	мс	7-6	MC = 6.6%		5.0 6618.
OTECH GR				LL = 29 PL = 19 Fines = 57.0%		Dawson Formation Interbedded SANDSTONE and CLAYSTONE, gray to bluish-gray, moist, hard to very hard
IDNAUP.	_					
NG GR 10	M	MC	50/10"			
ž 10					_	
NGN.]					
	-					
NIATAIN 15	M	MC	50/10"	MC = 5.6%	-	
N 10				DD = 126.4 pcf UCS = 11,752		
RS/BRYSE	-			PSF, Shear Strength = 5,876 PSF		
INDE	L					
<u>6</u> 20	M	MC	50/6"	MC = 12.5% DD = 119.6 pcf		
6/22 1	-			UCS = 11,516 PSF, Shear		
1	-			Strength = 5,758 PSF		
GENERAL BH / TP / WELL - MODIFIED - GINT STD US LAB GDT 0.00 PL 0.00 P						
25 25	-				_	
ES .	-				• • •	
<u>5</u> -	1					
	L				_	
30	M	MC	50/7"			
_ WEL	-					
#L .	-				_	
RAL B	1					
B 35						
						(Continued Next Page)

CLIEN PROJ (#)	IVID neering Graup	1053 Elkto Colorado	Springs, Colorado e: 719-896-4356		BORING NUMBER B-3,
CLIEN	IT Water		0.470		PROJECT NAME Proposed Middle Tributary Channel Improvements
PROJ		BER _D21-	2-470		PROJECT LOCATION Colorado Springs, Colorado
(#) 35	SAMPLE TYPE NUMBER	BLOW COUNTS (N VALUE)	TESTS	GRAPHIC LOG	MATERIAL DESCRIPTION
 					Dawson Formation Interbedded SANDSTONE and CLAYSTONE, gray to bluish-gray, moist, hard to very hard (continued)
	MC M	50/3"		39.3	Bottom of borehole at 39.3 feet.



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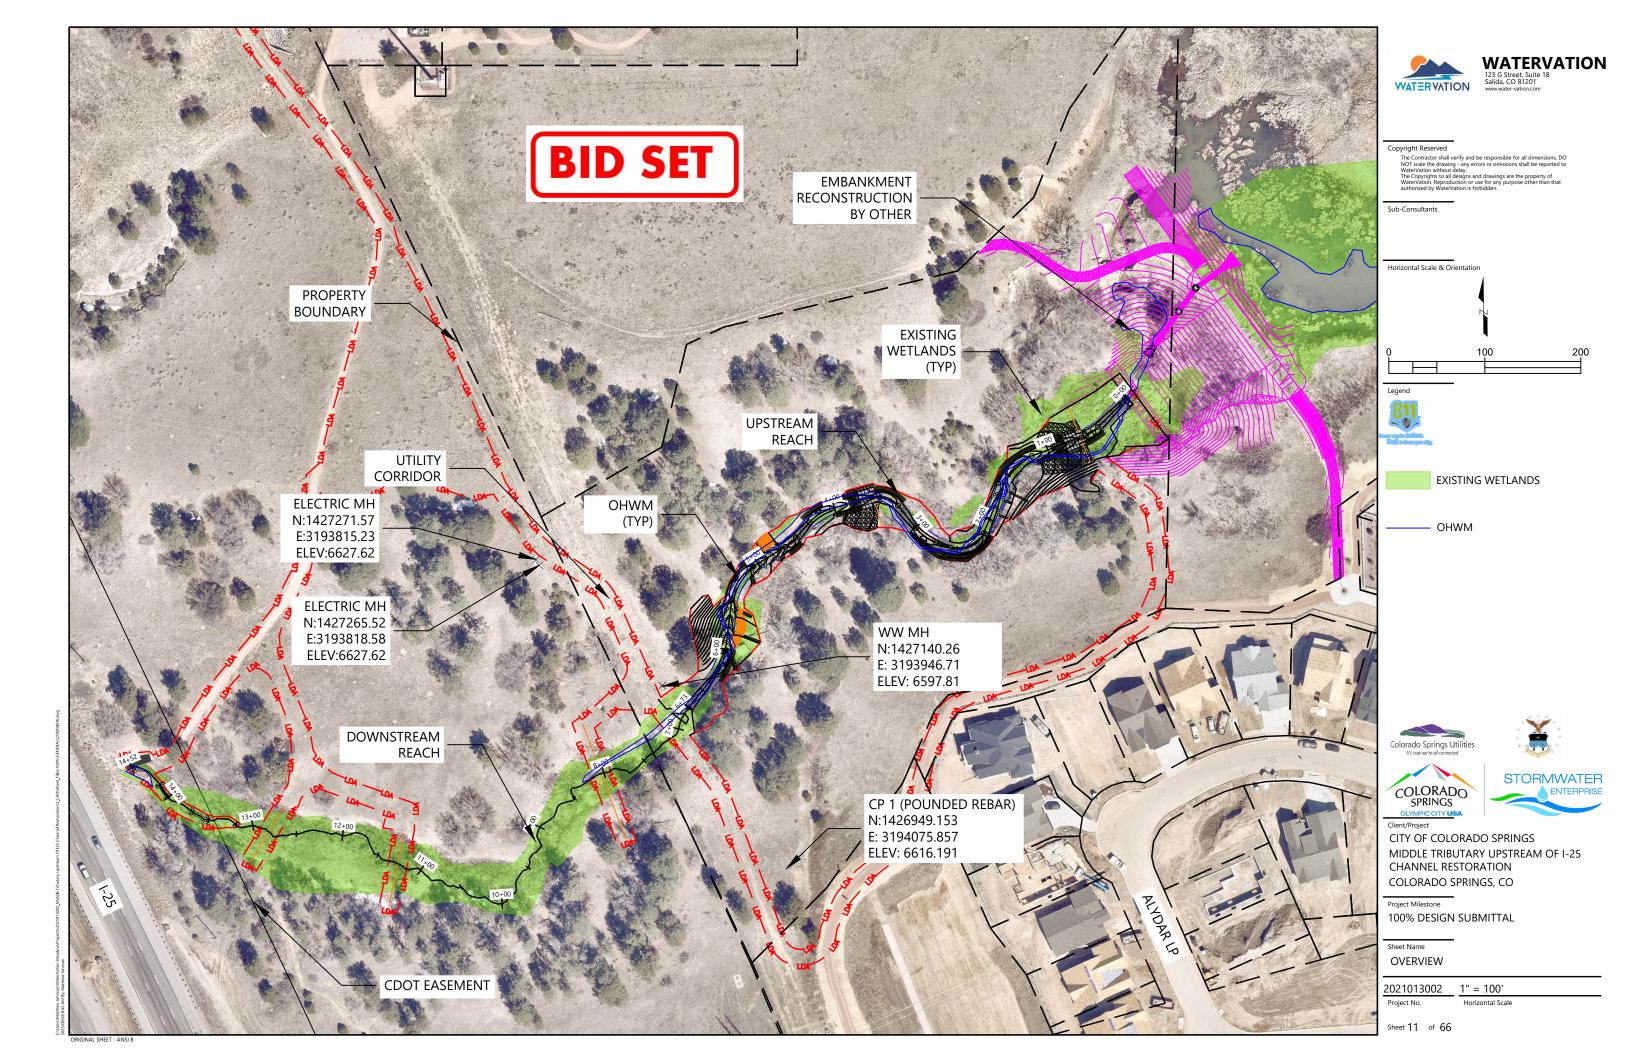
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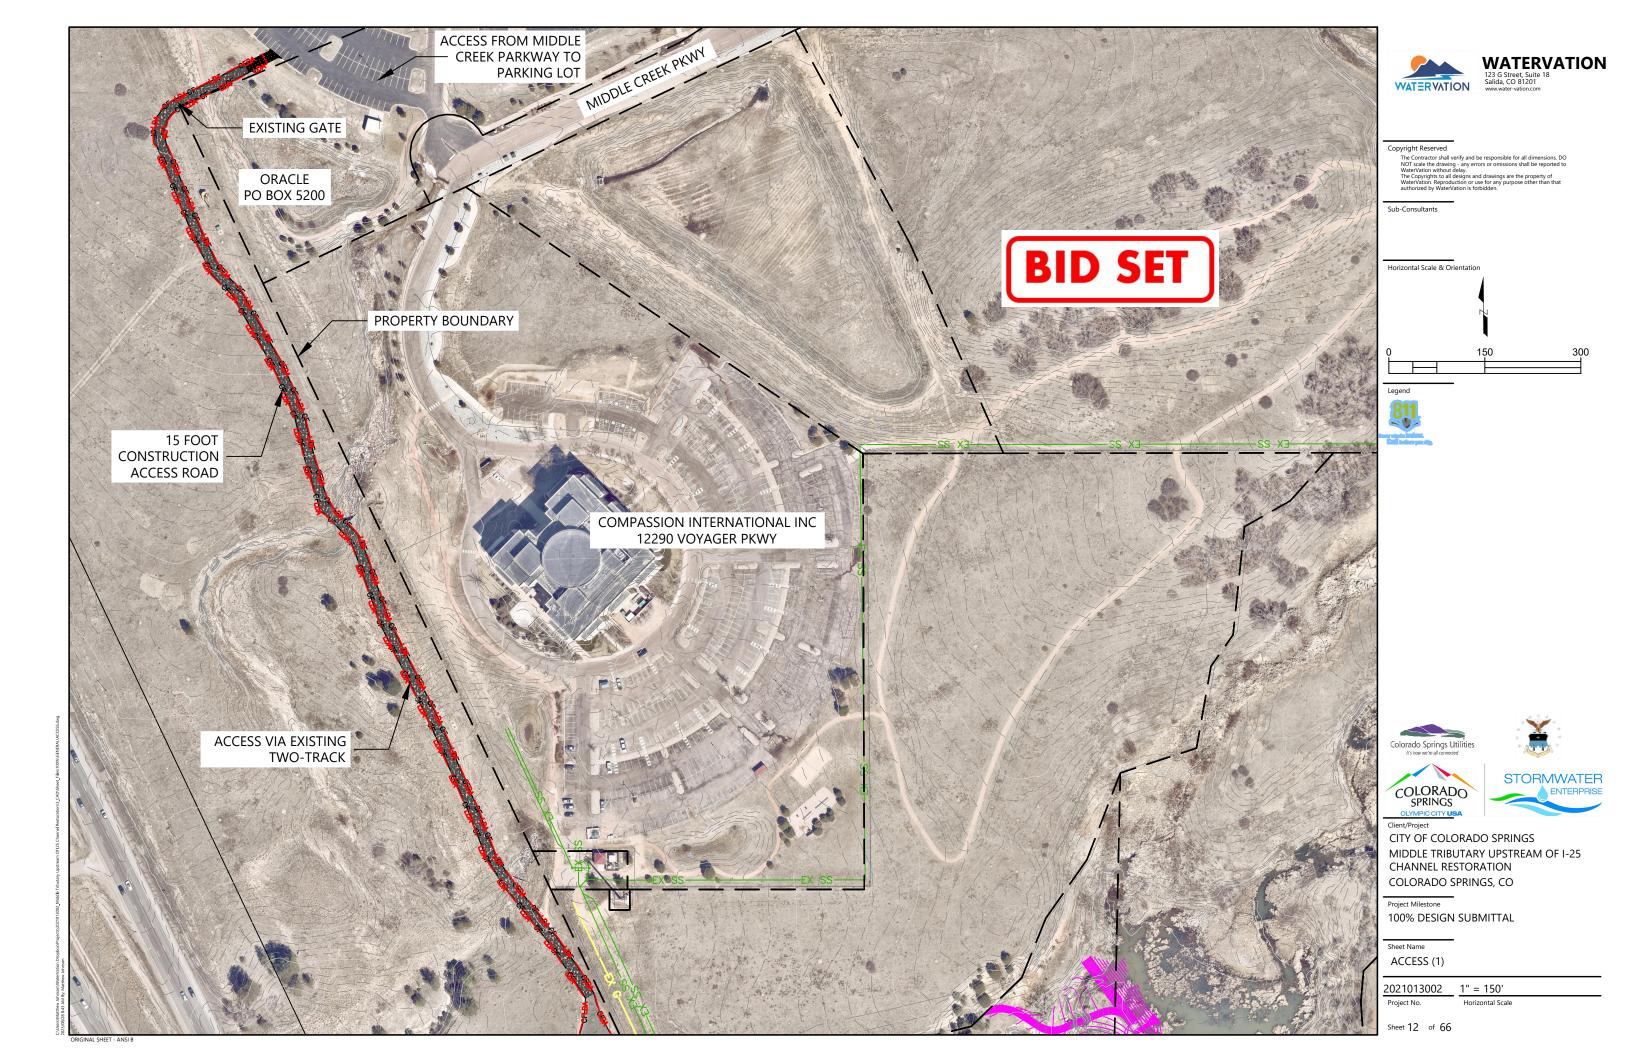
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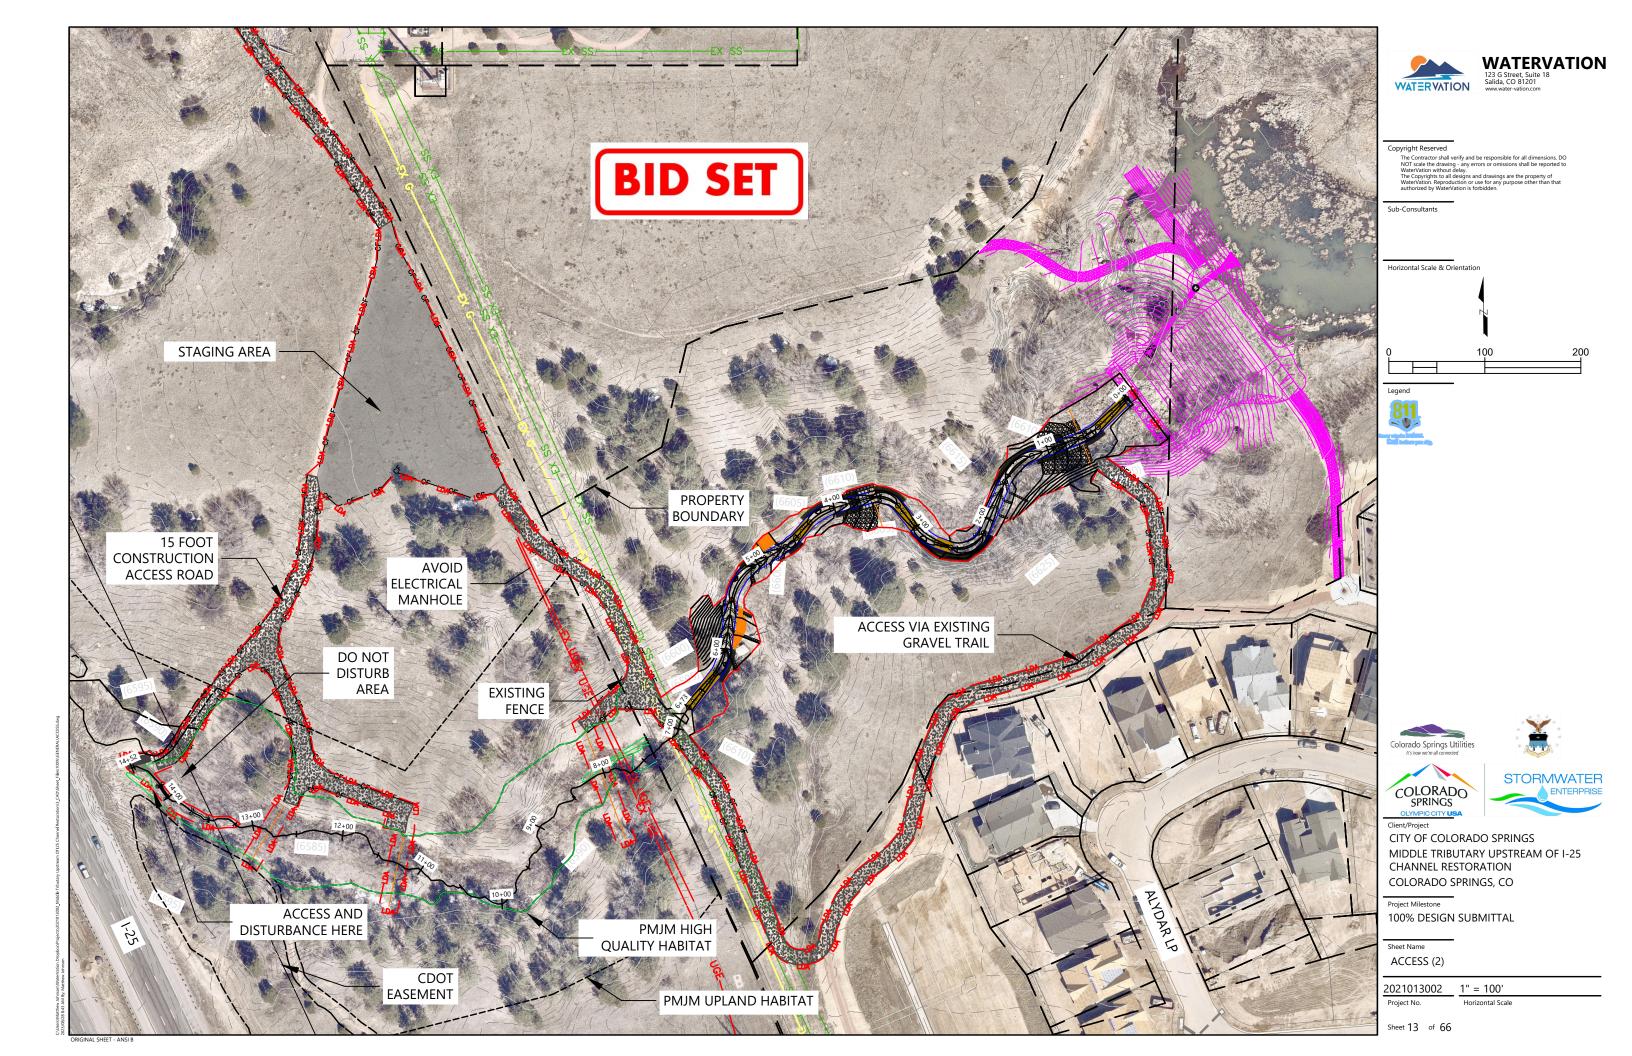
GEOTECHNICAL BORING (3)


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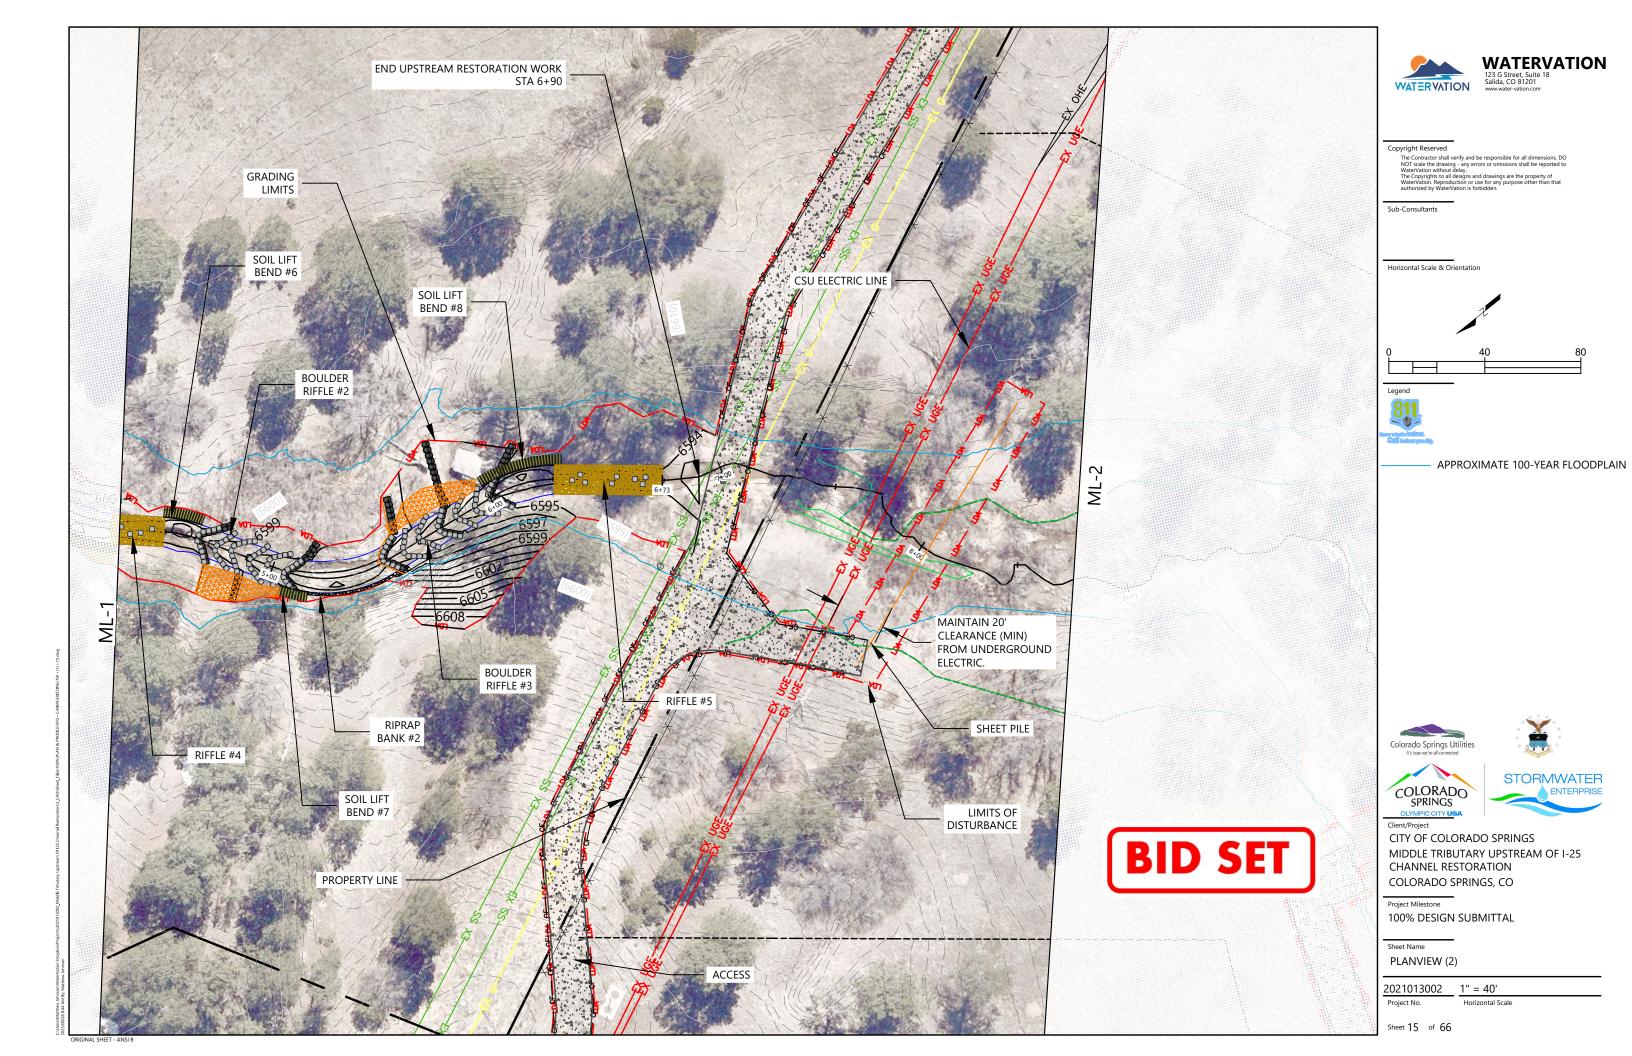
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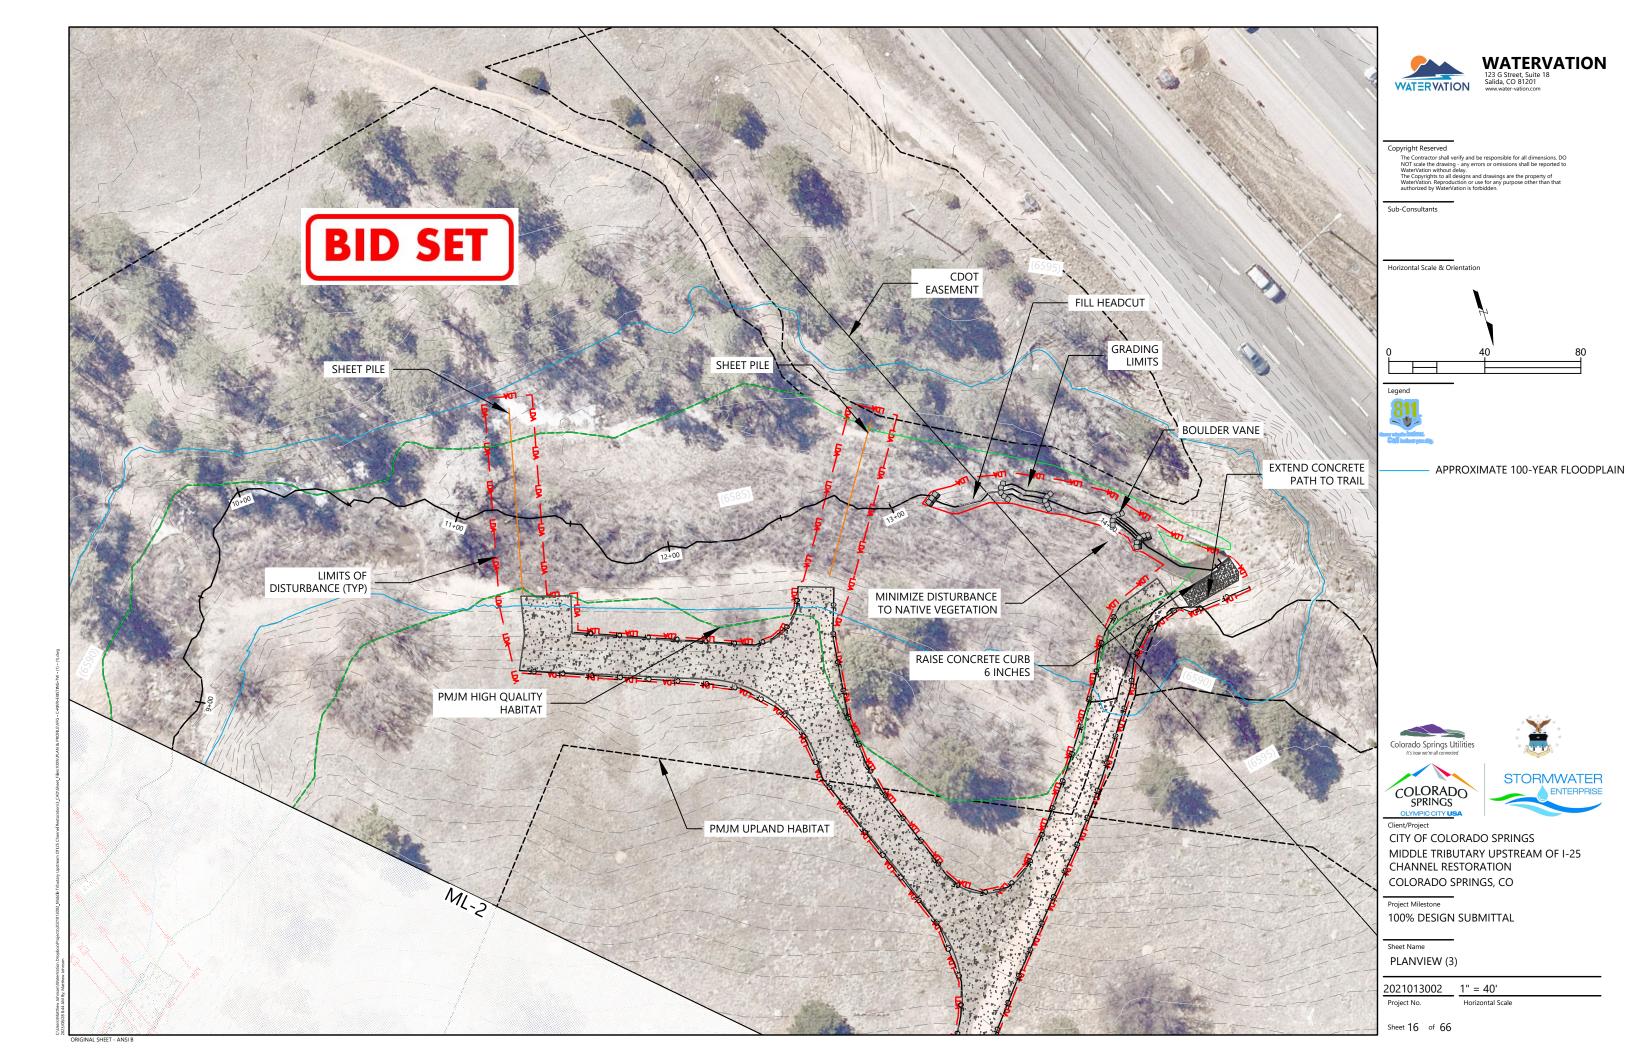














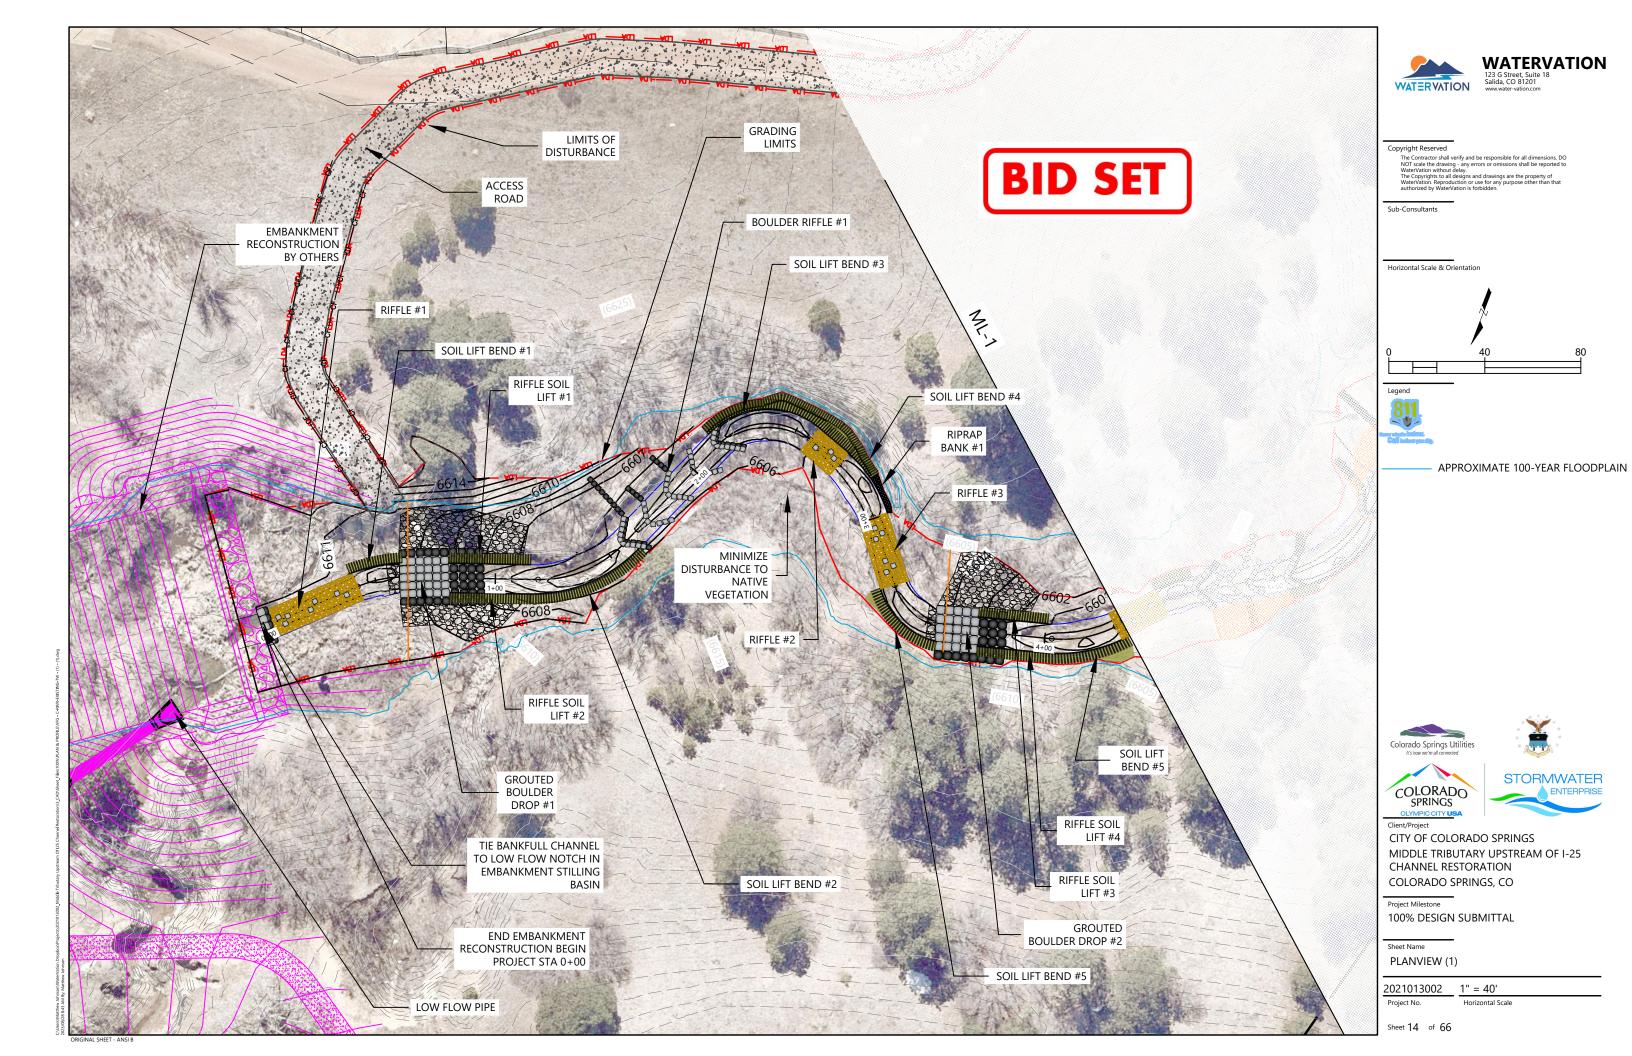


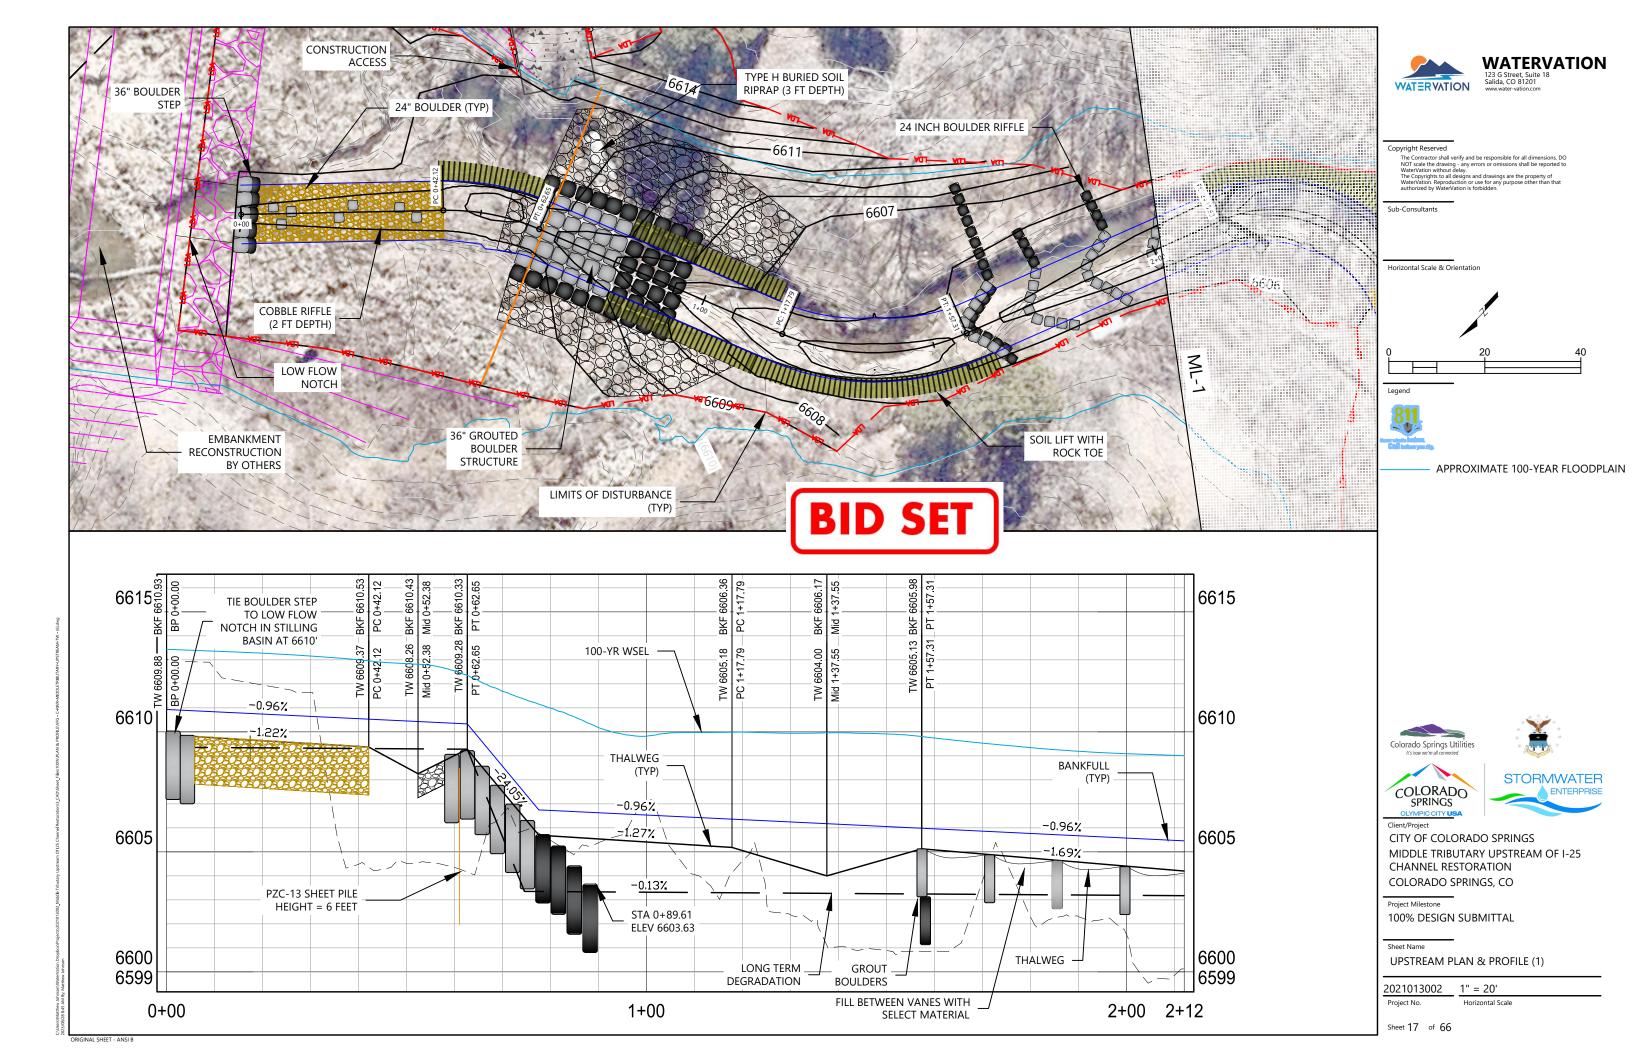


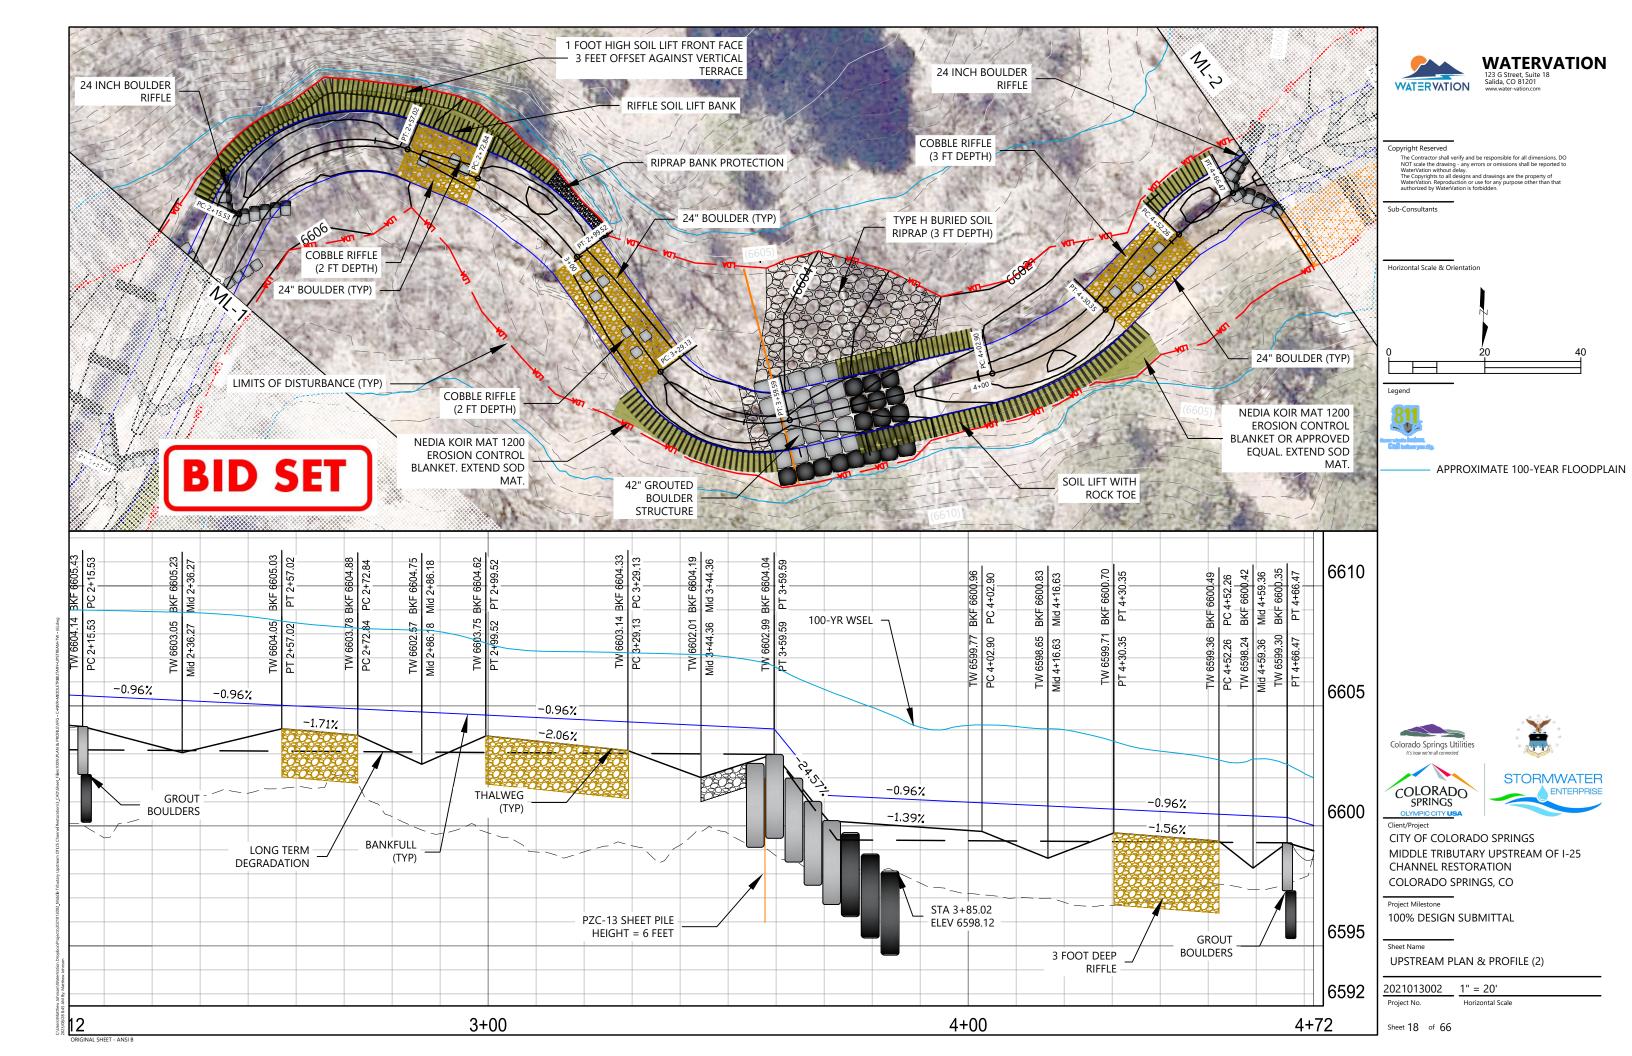


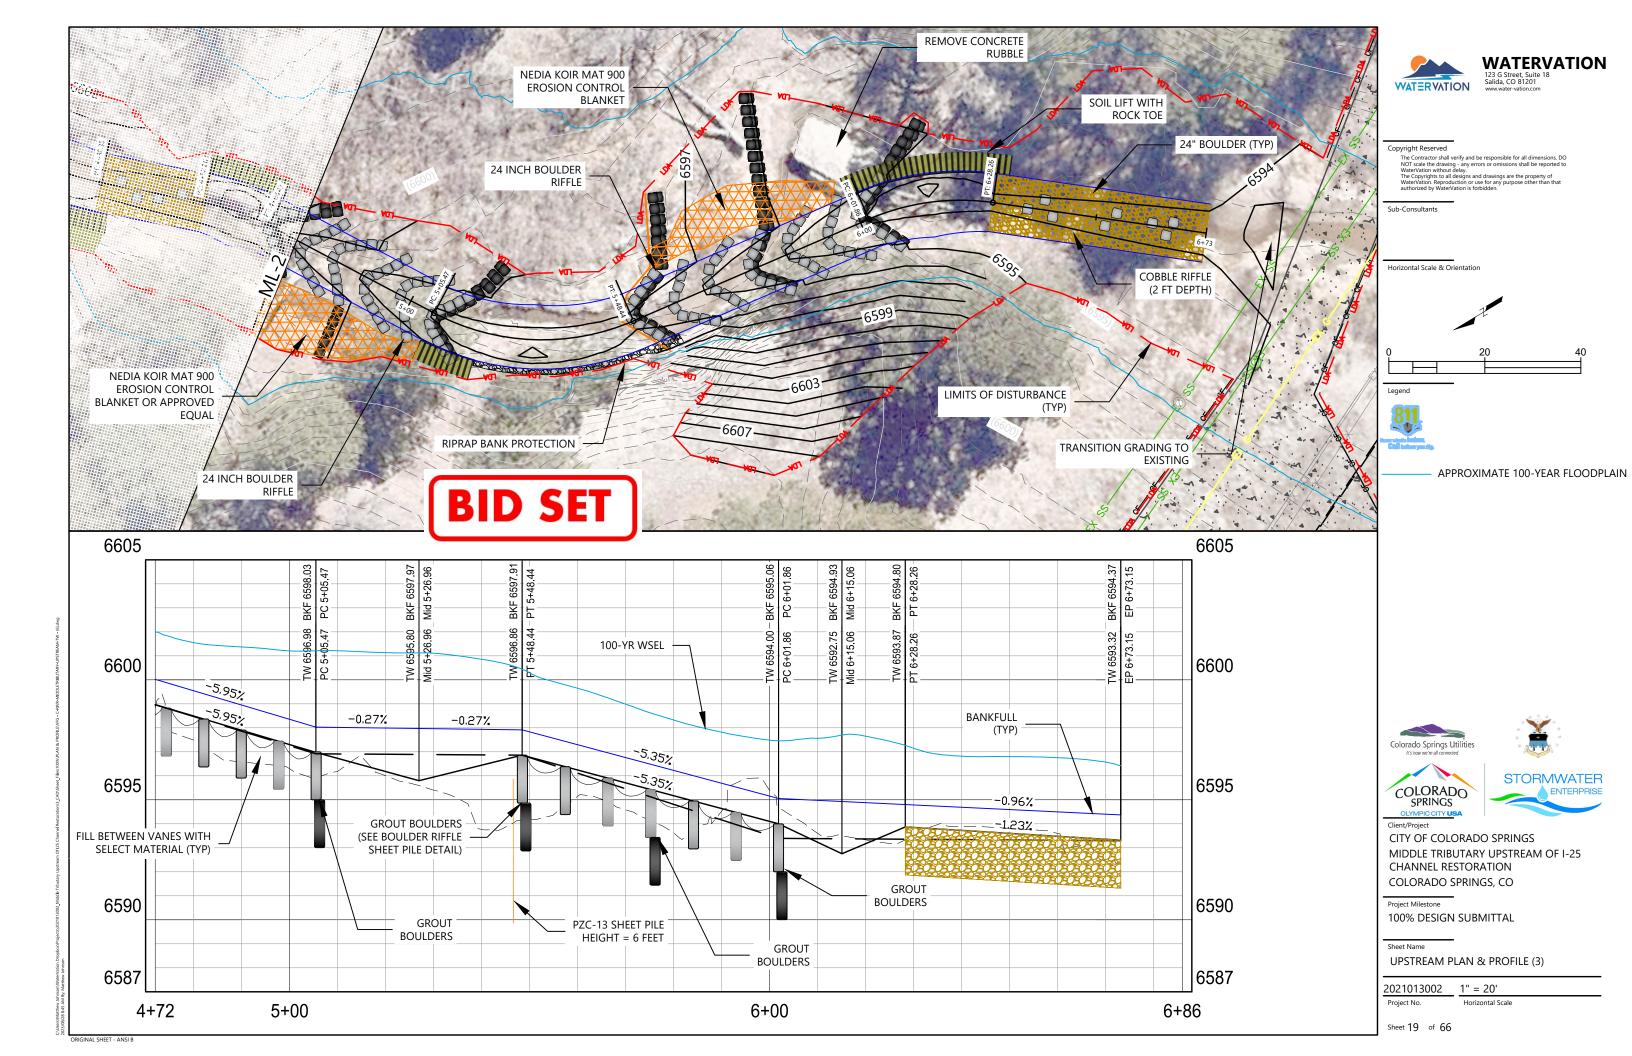


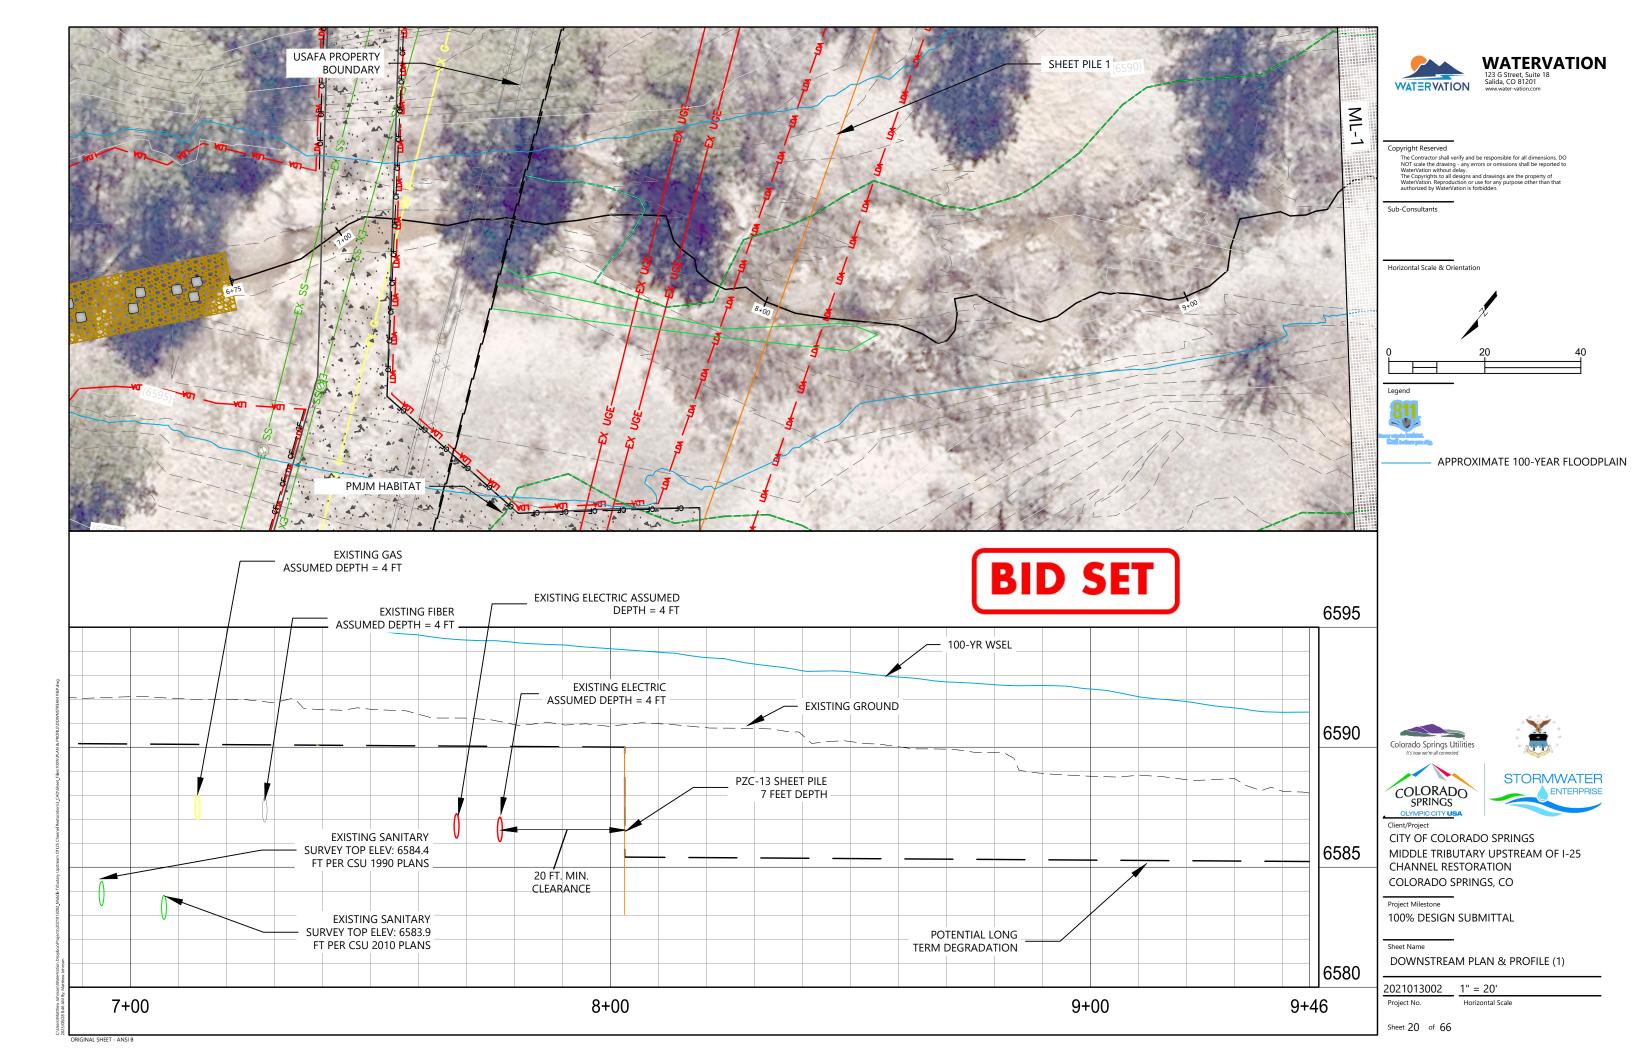


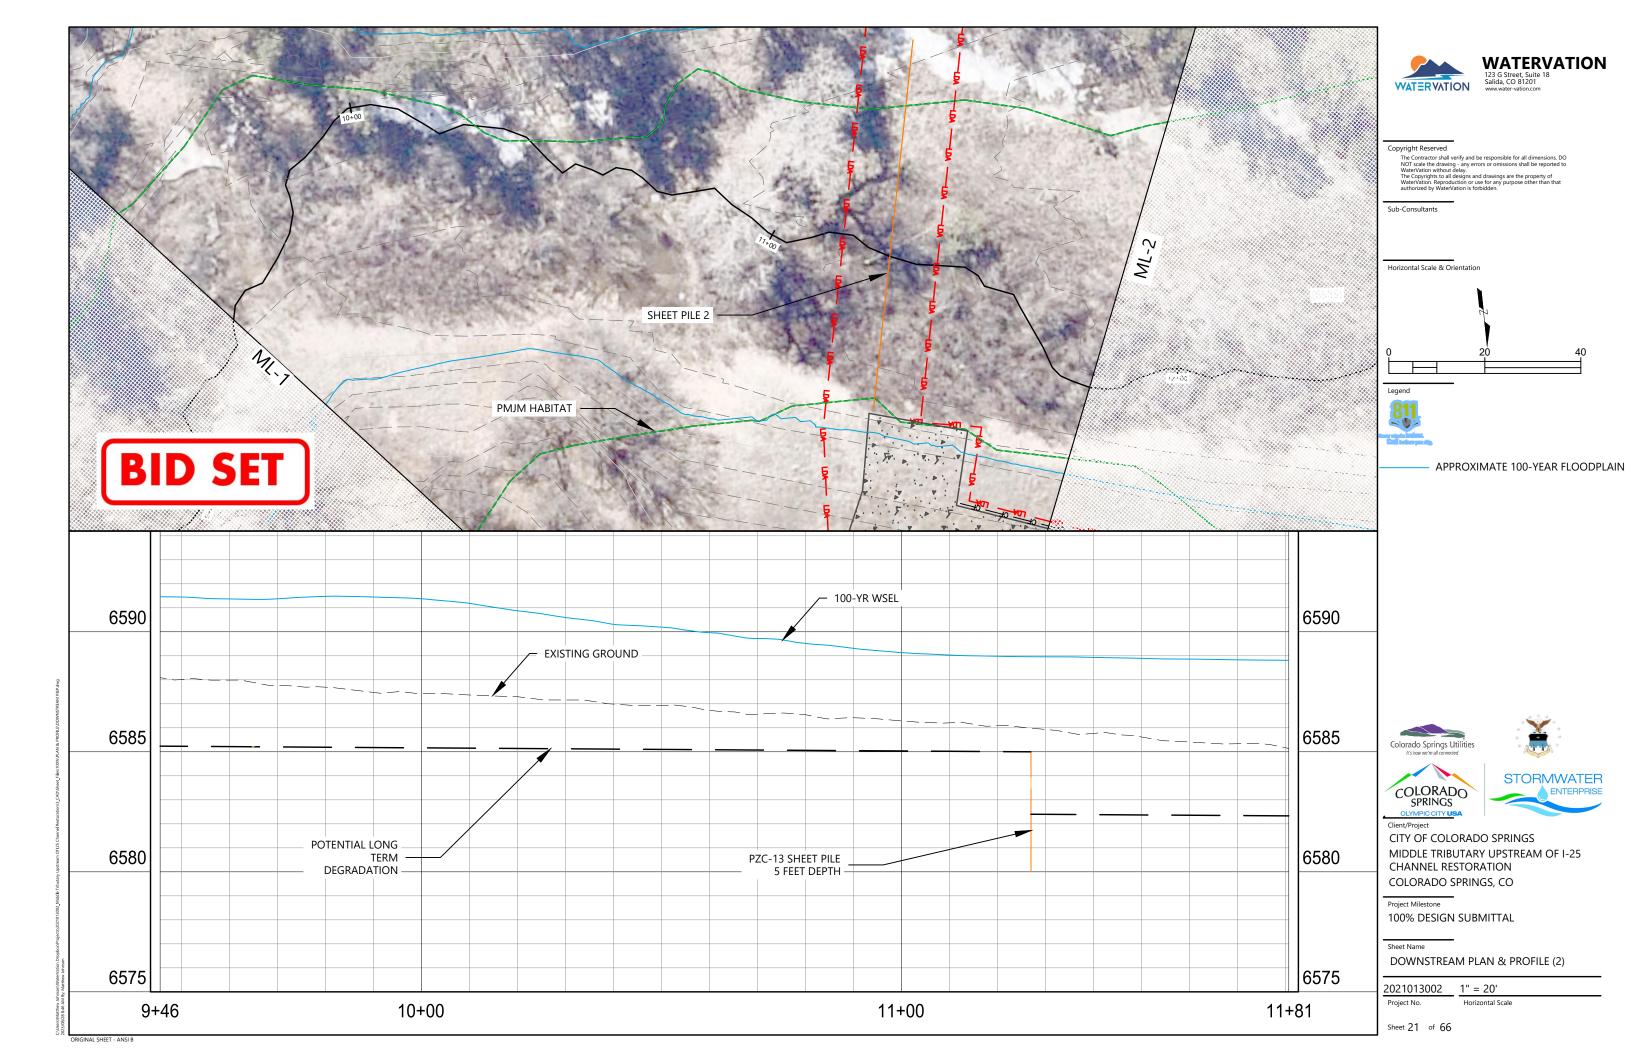


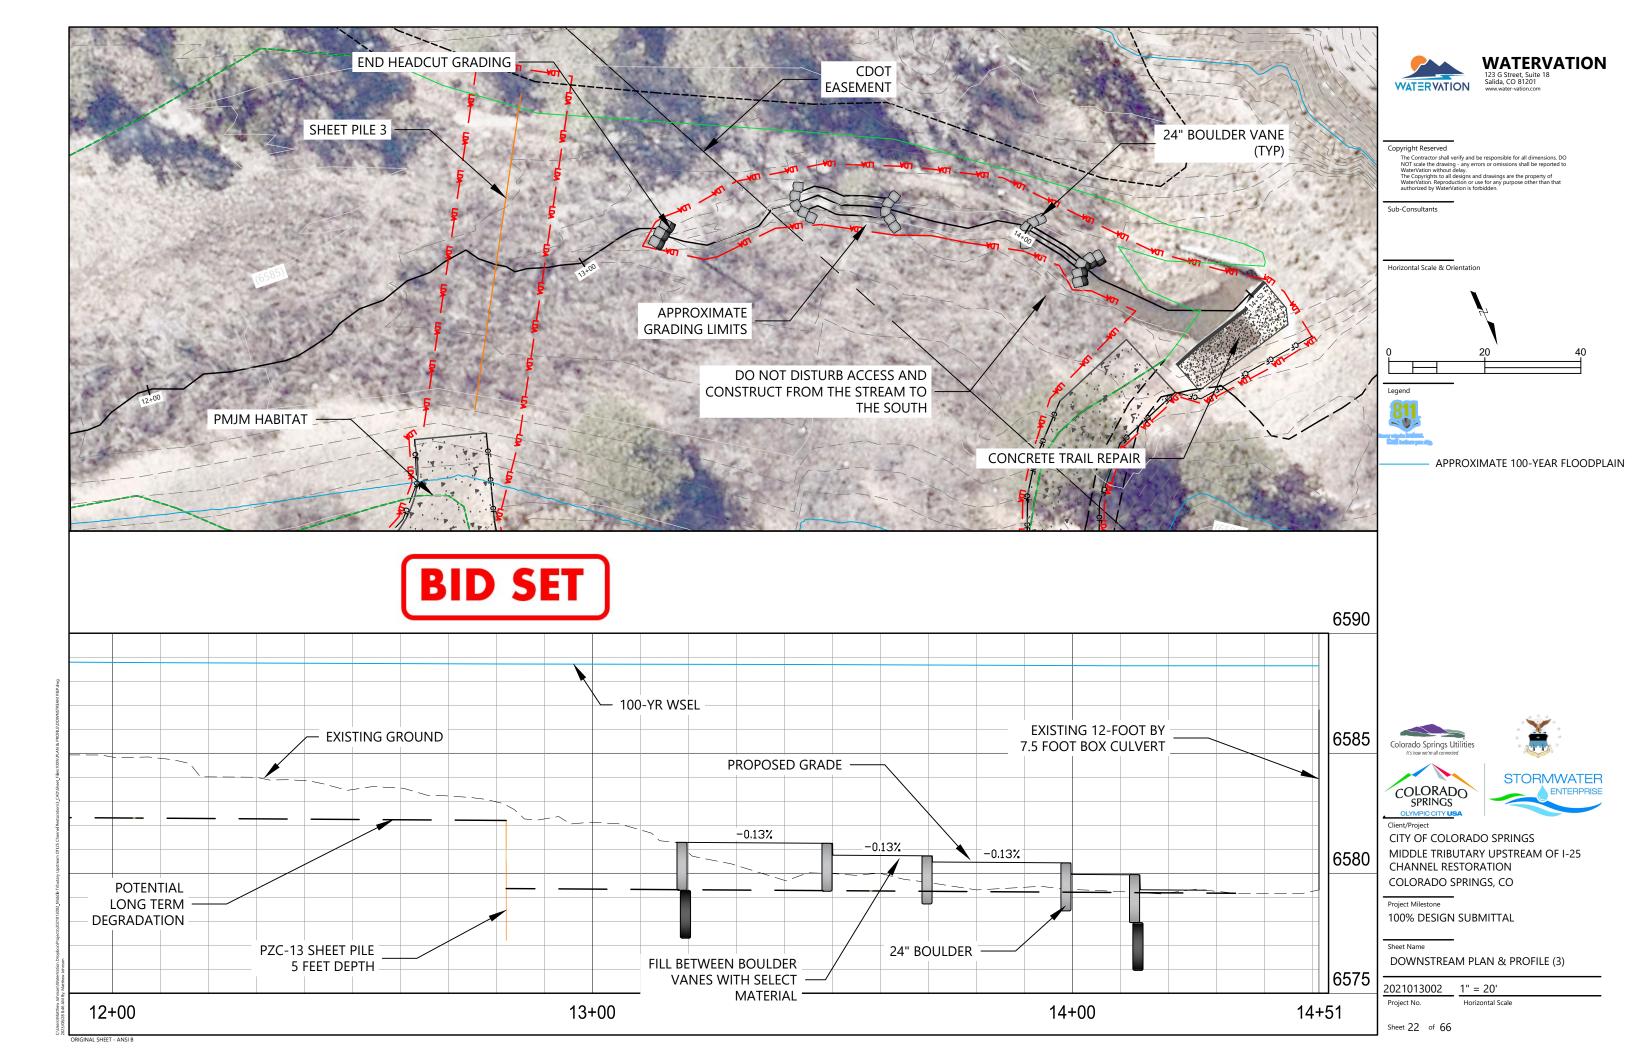


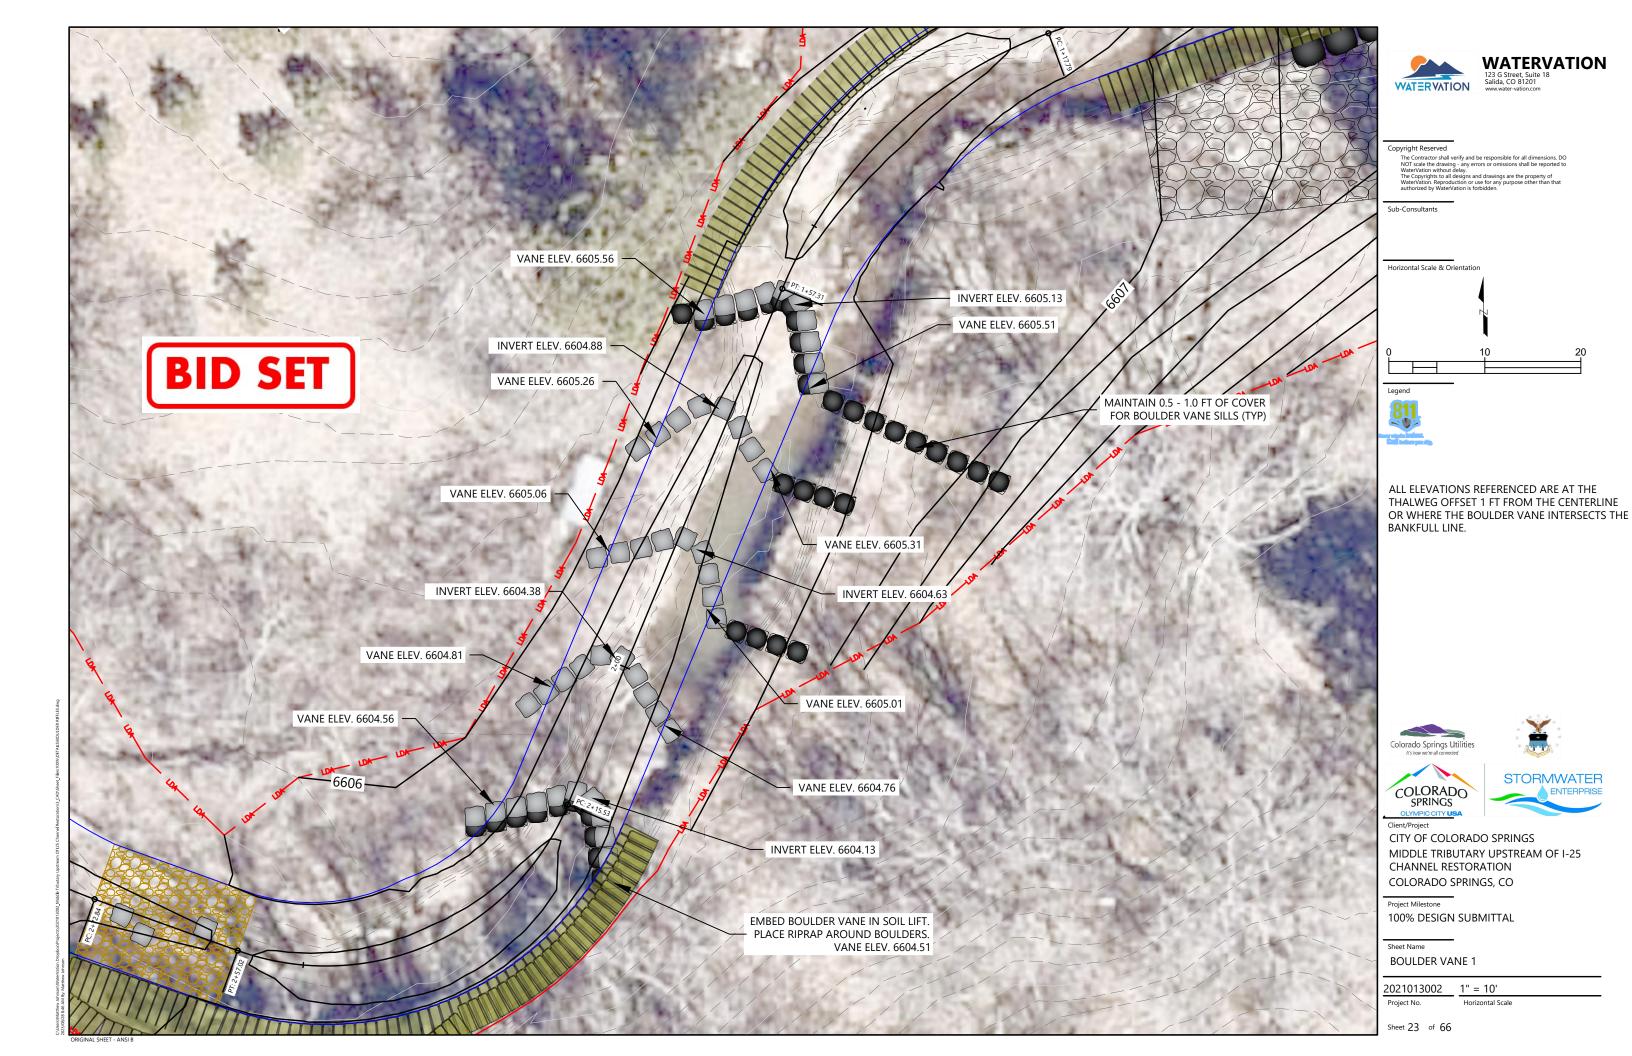


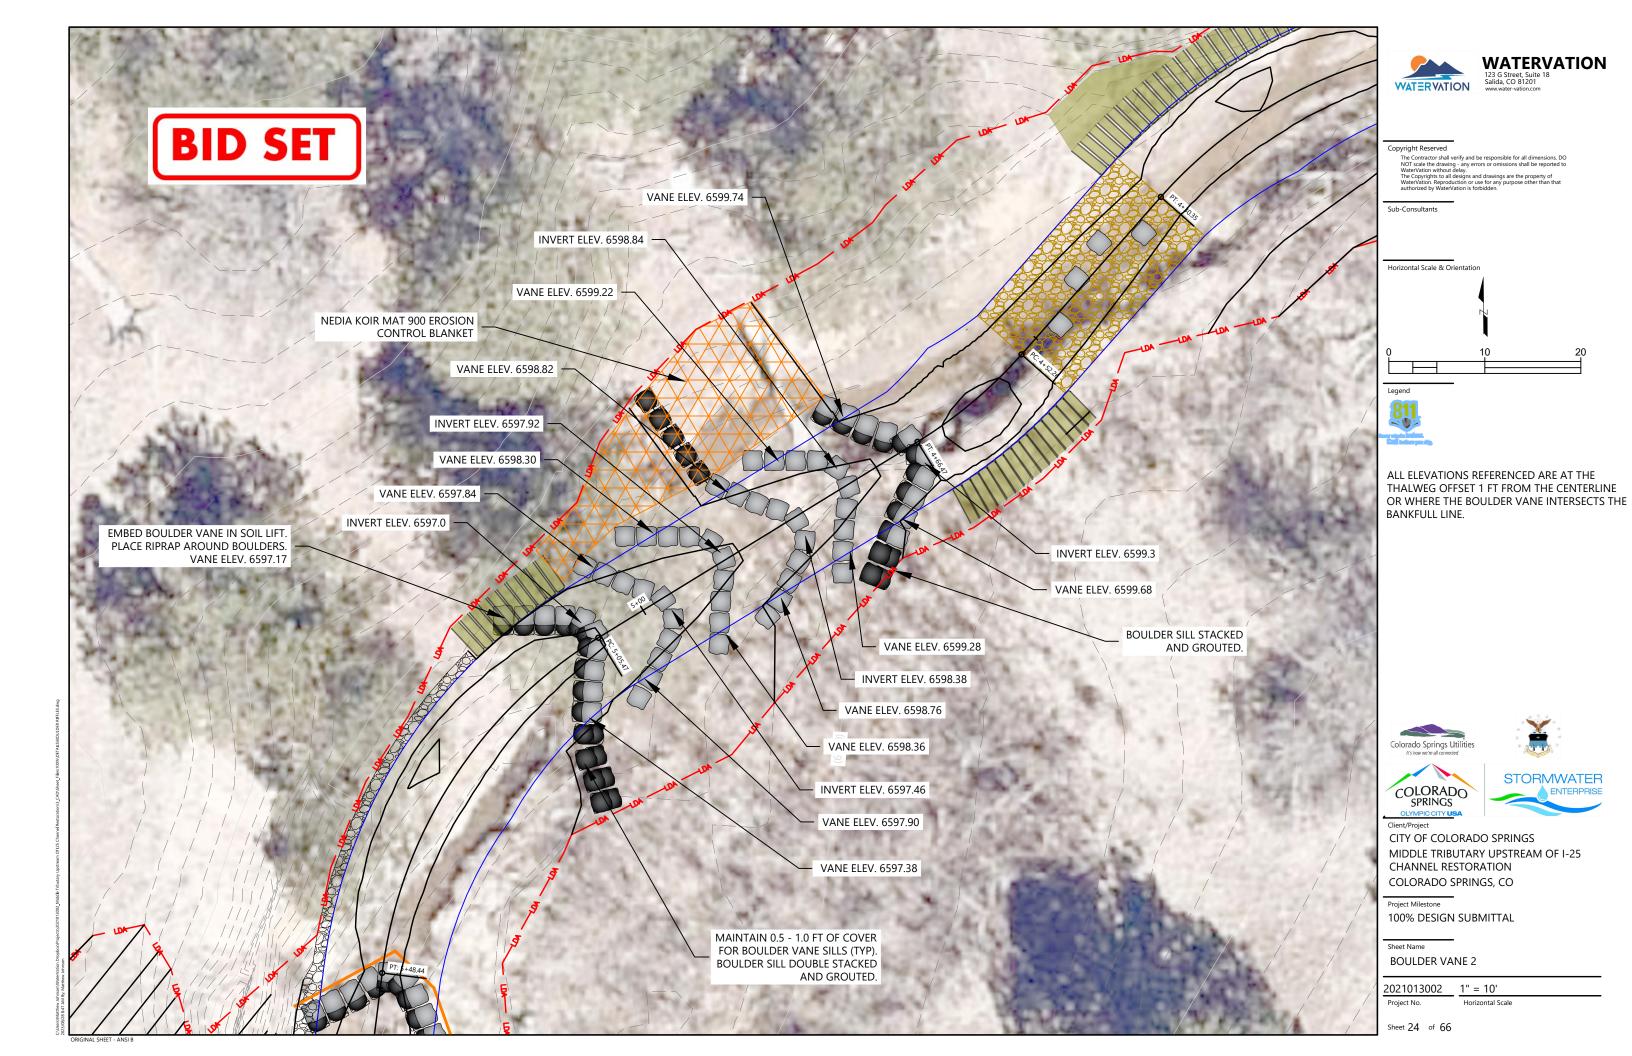


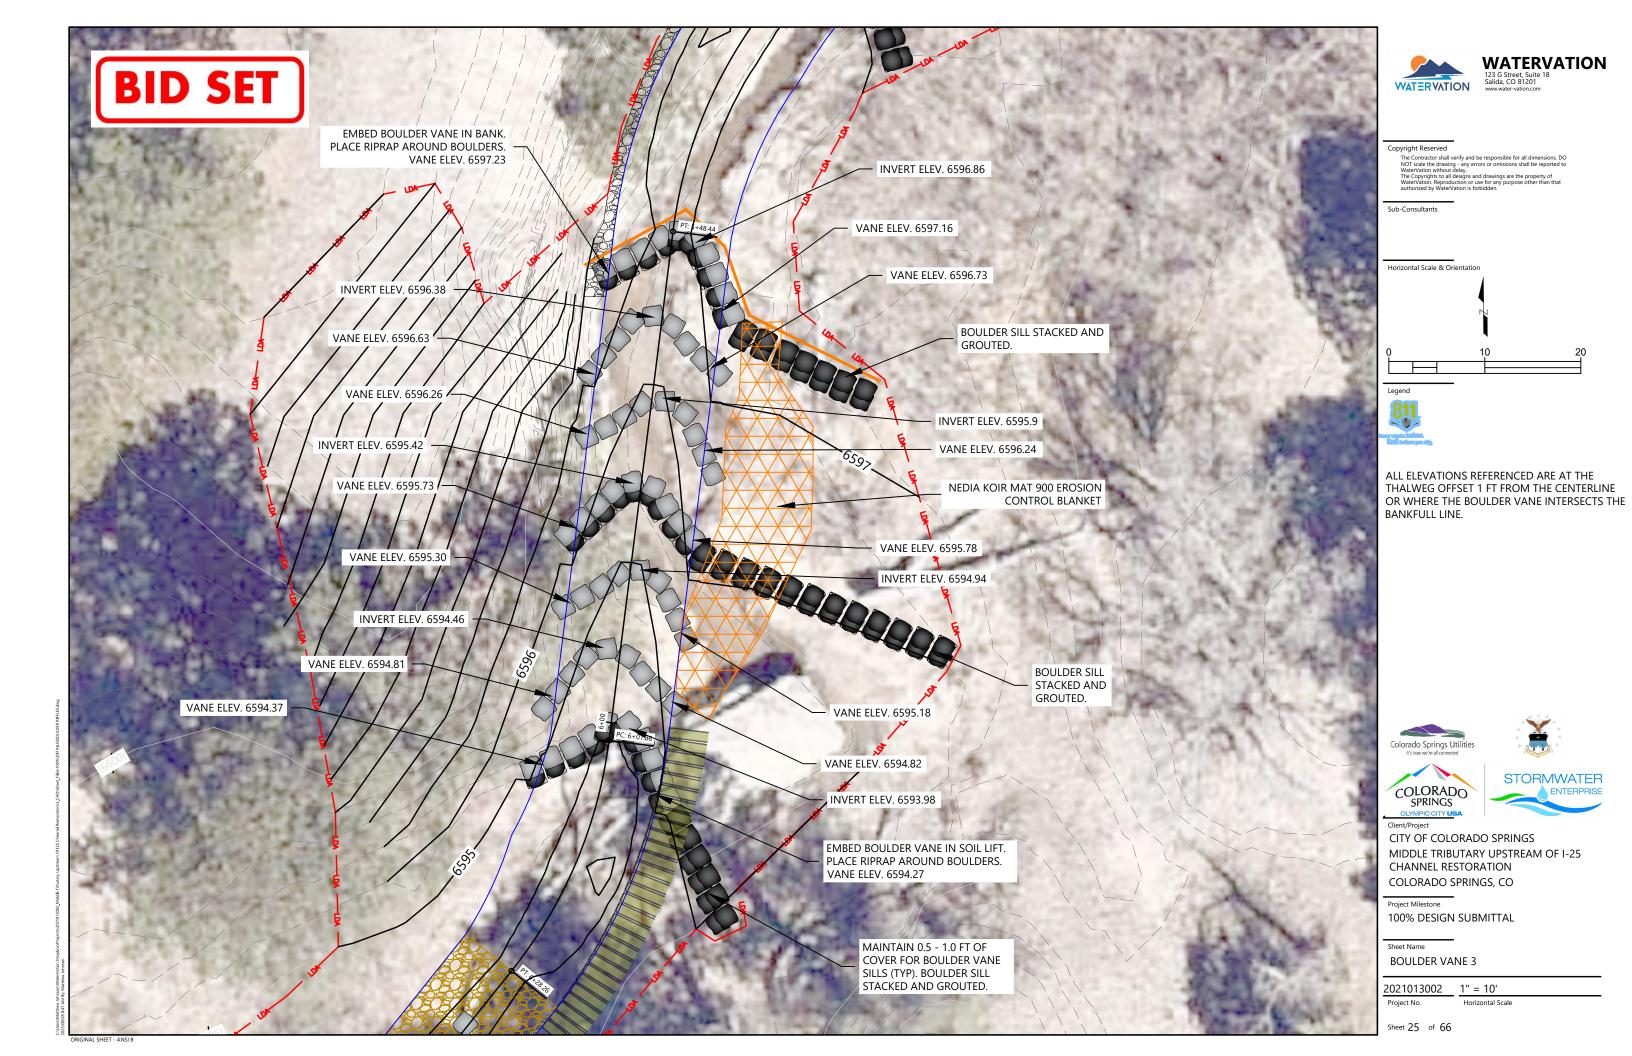


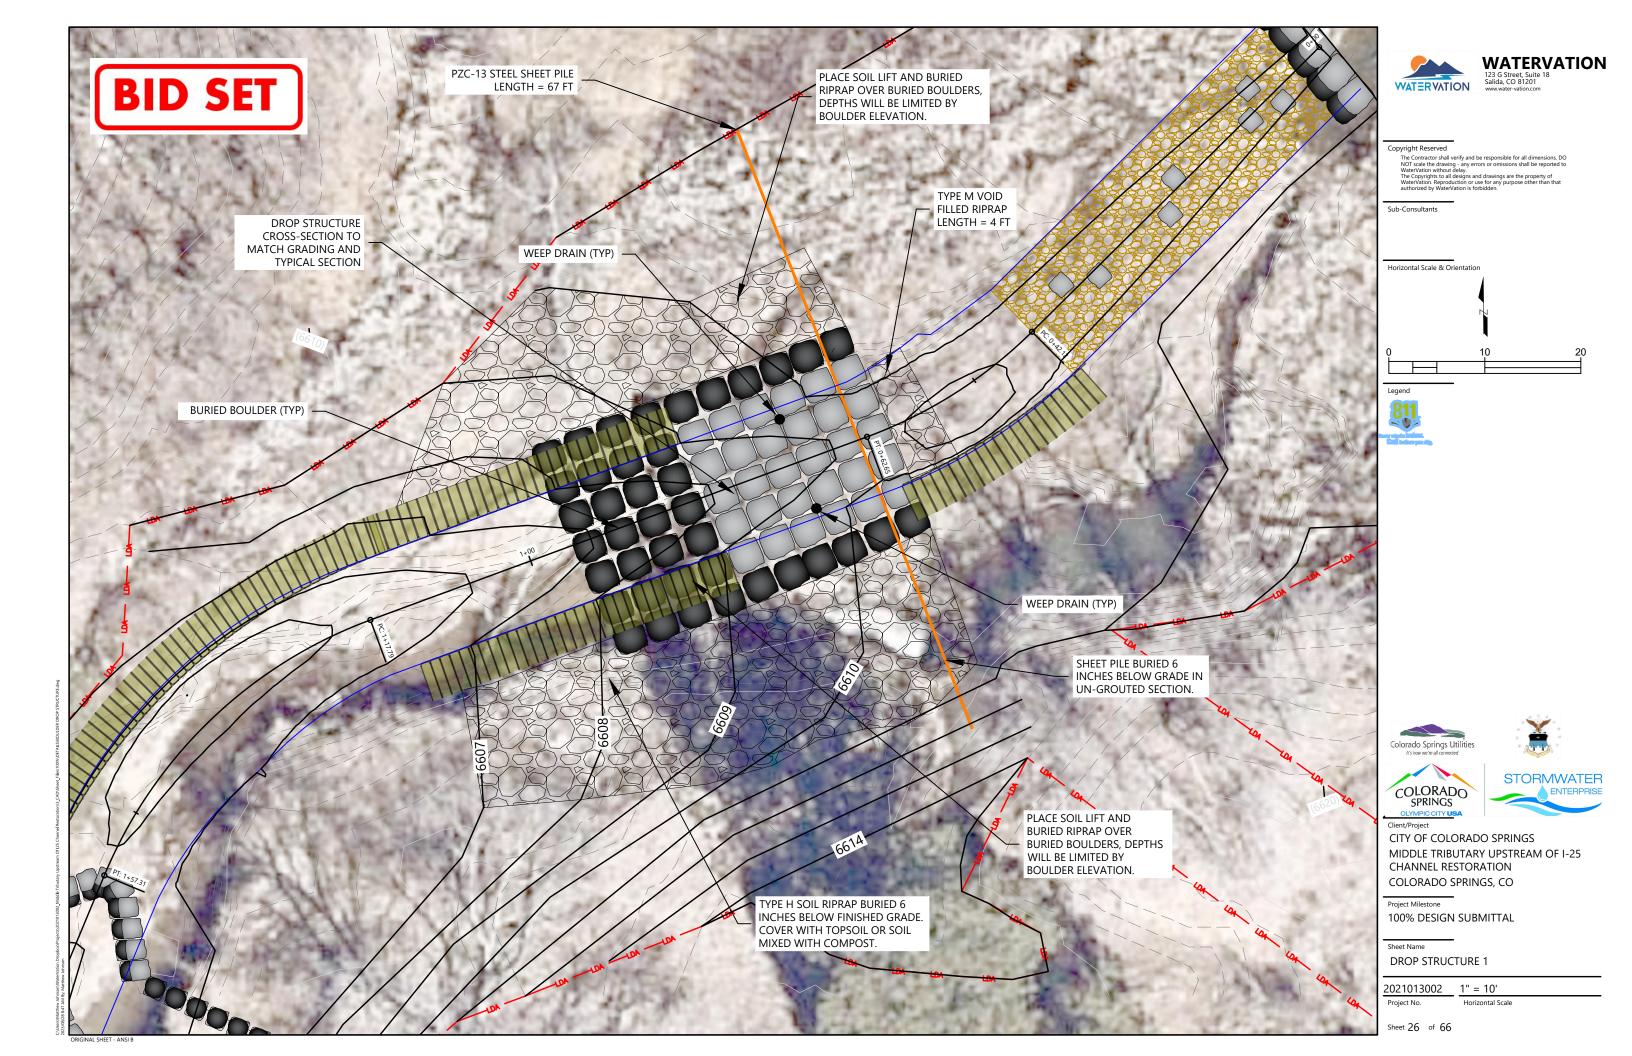


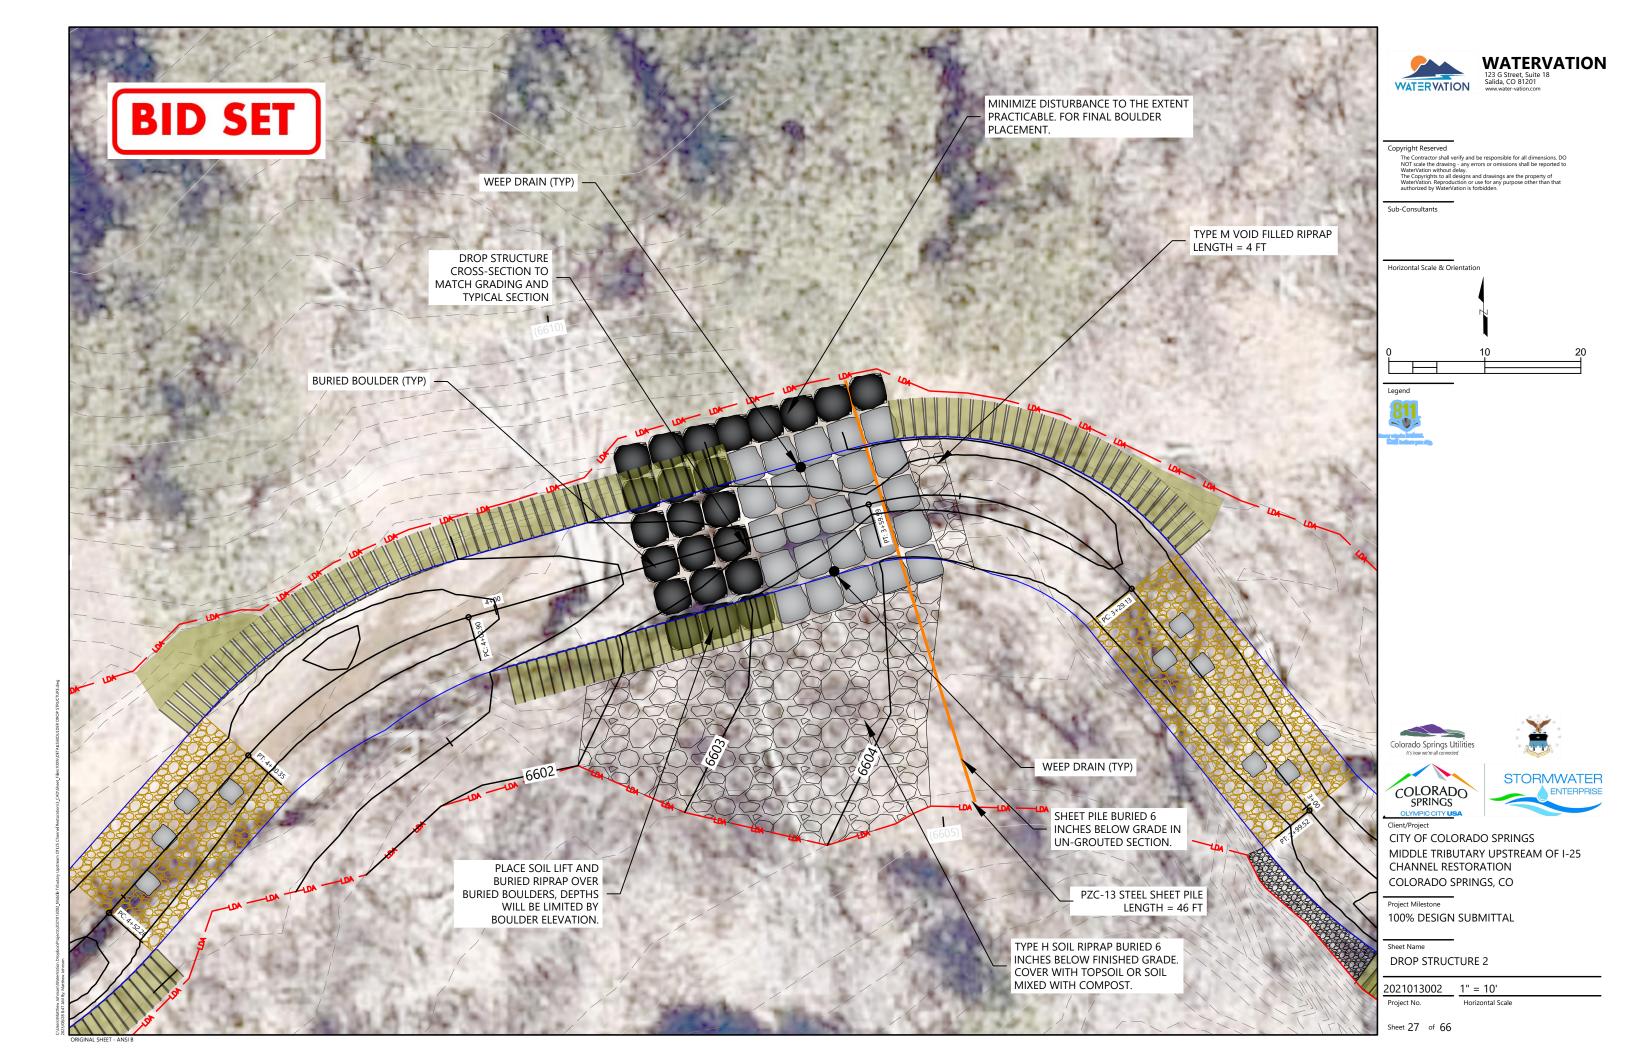

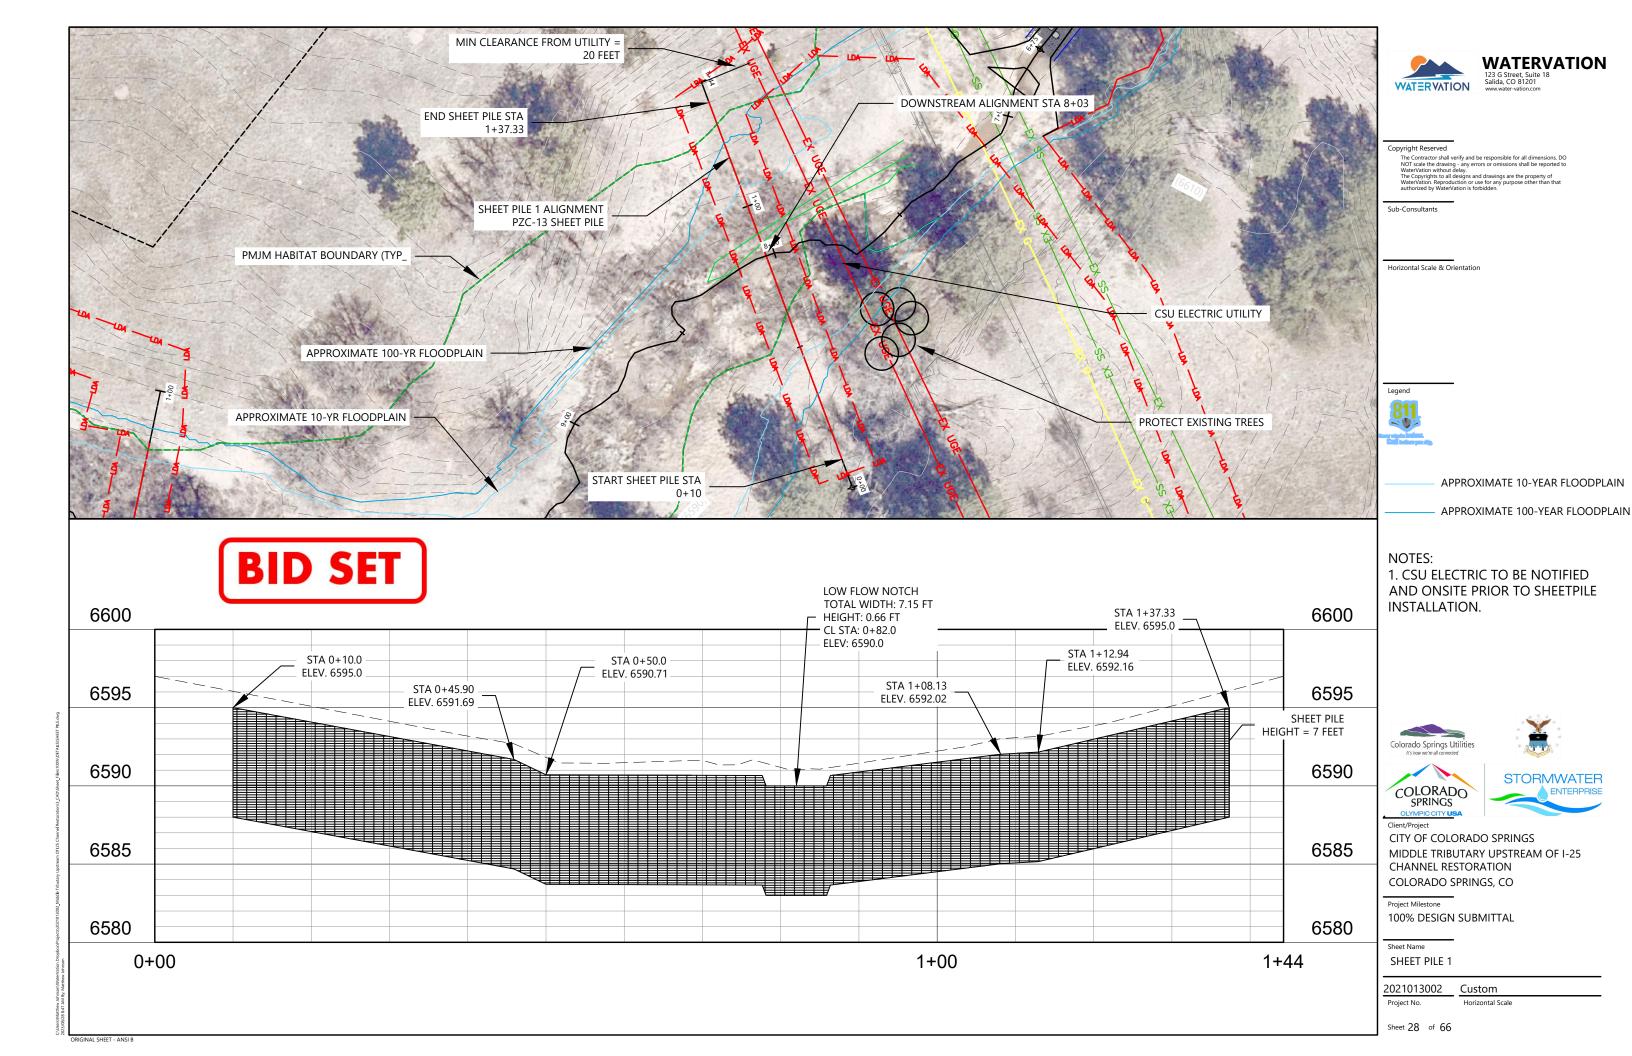

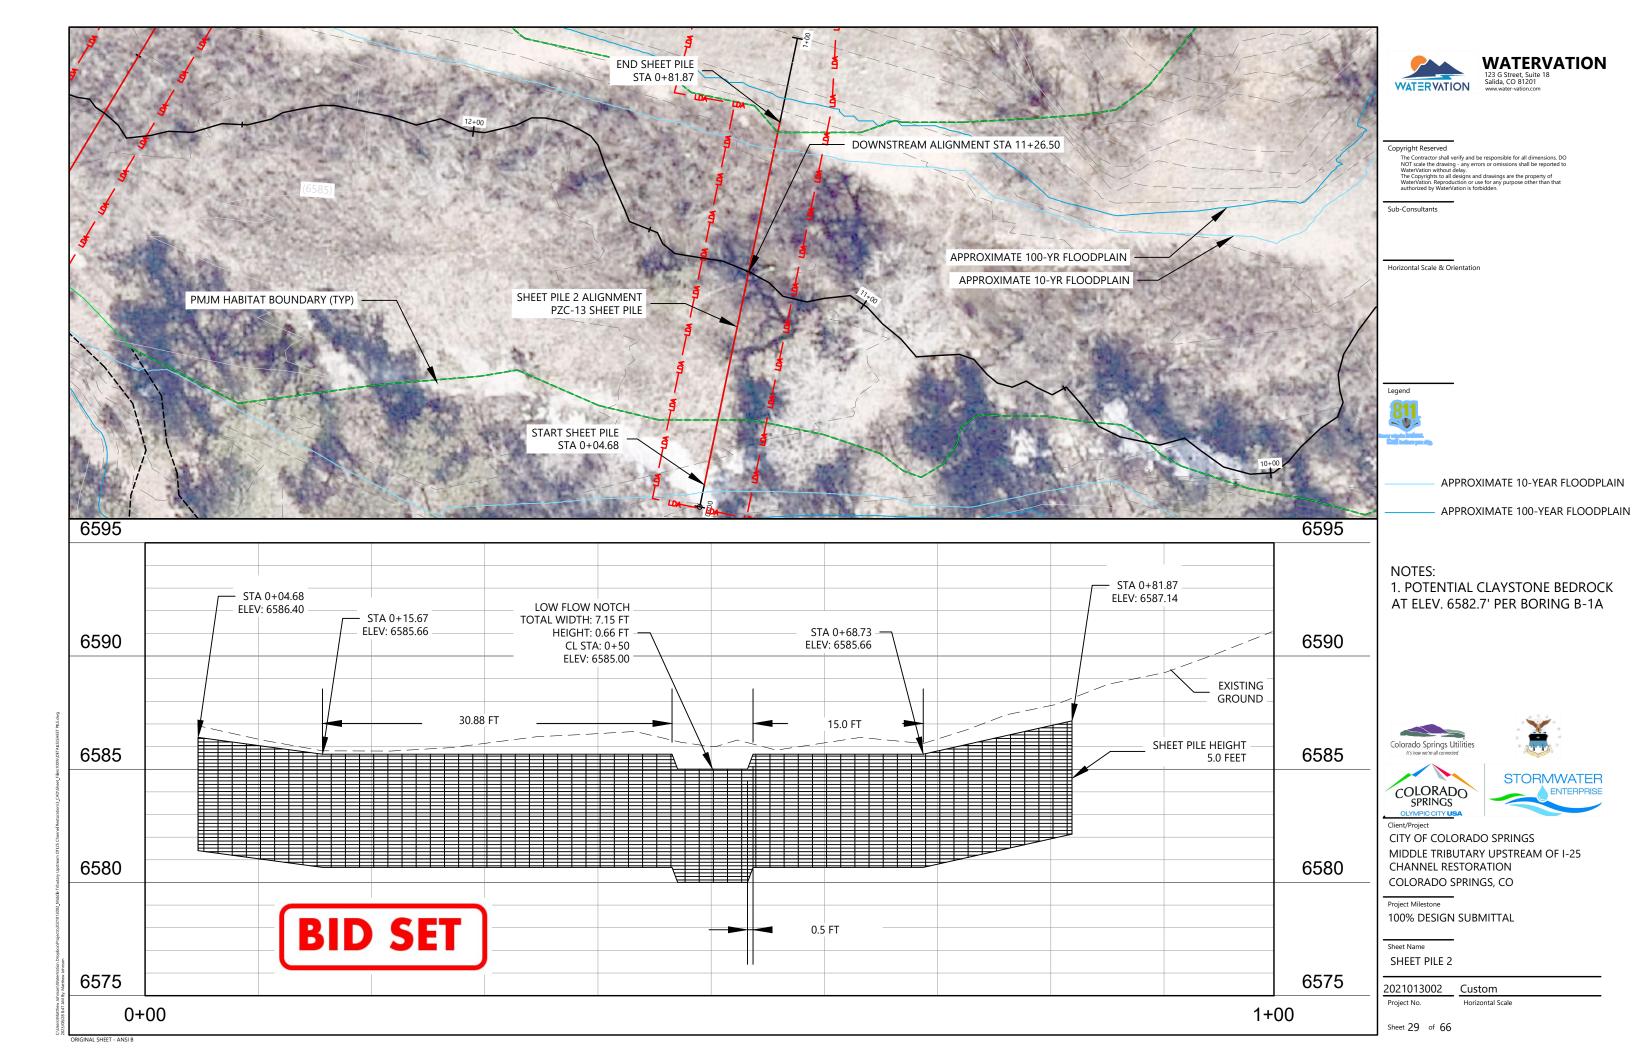


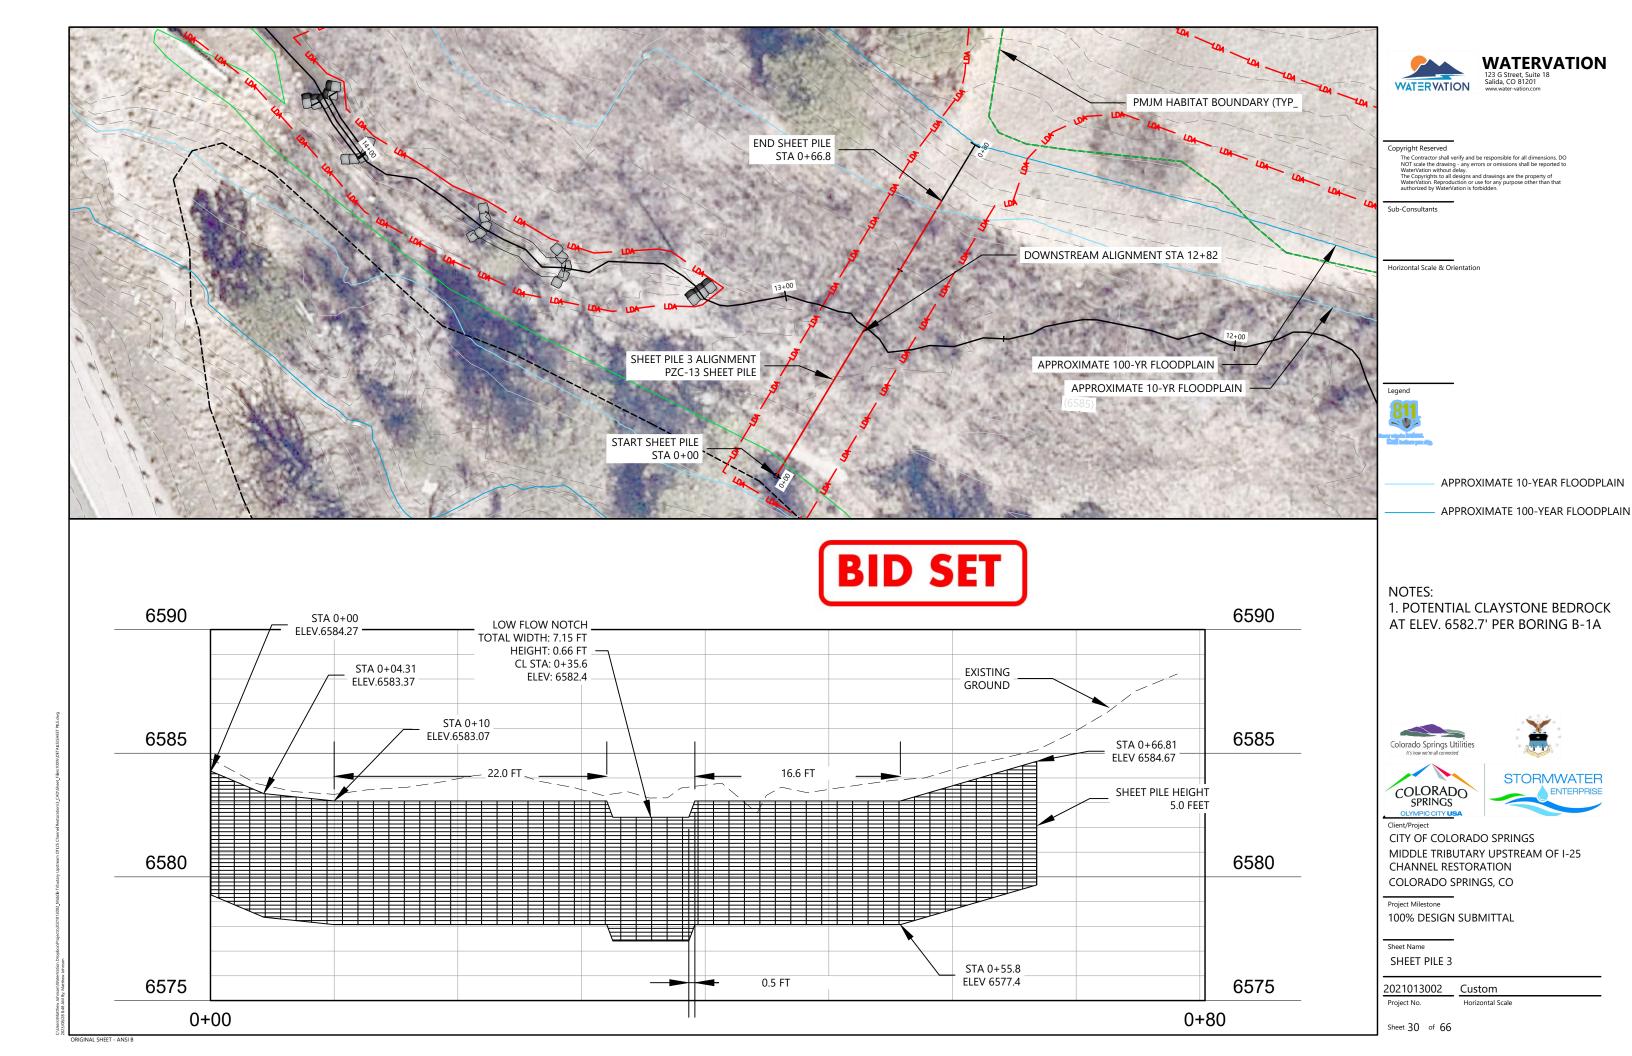

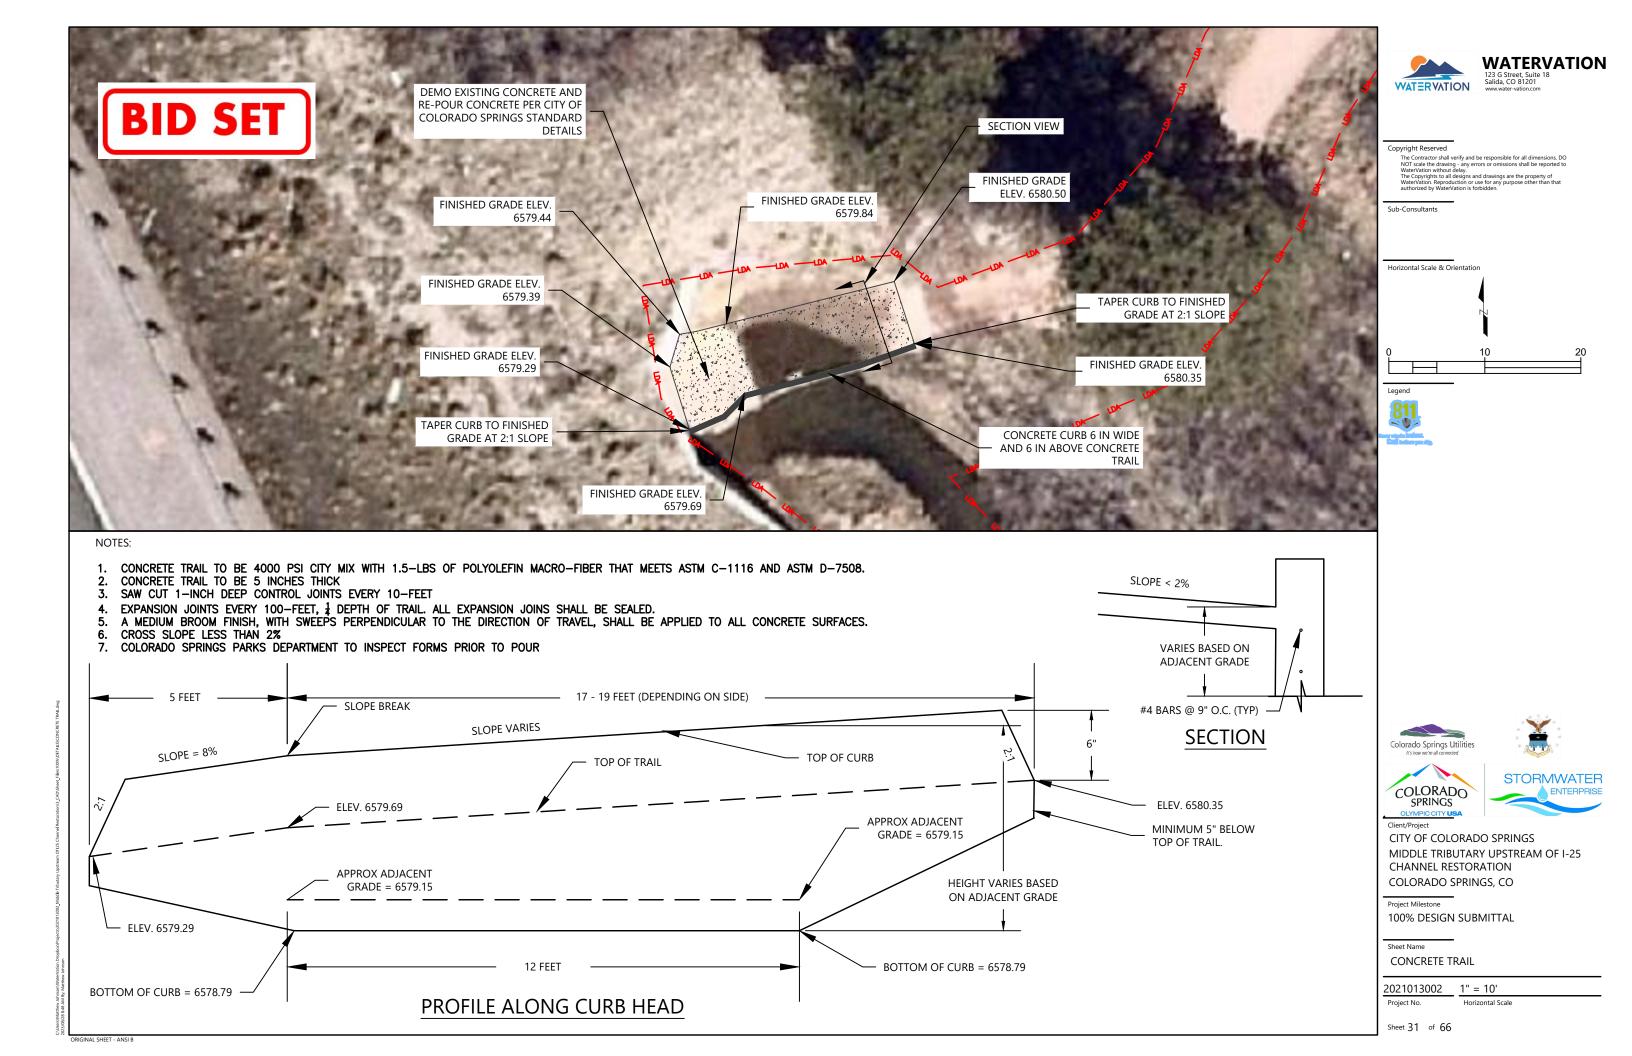


TYPICAL MAIN CHANNEL SECTION - RIFFLE SCALE: NTS



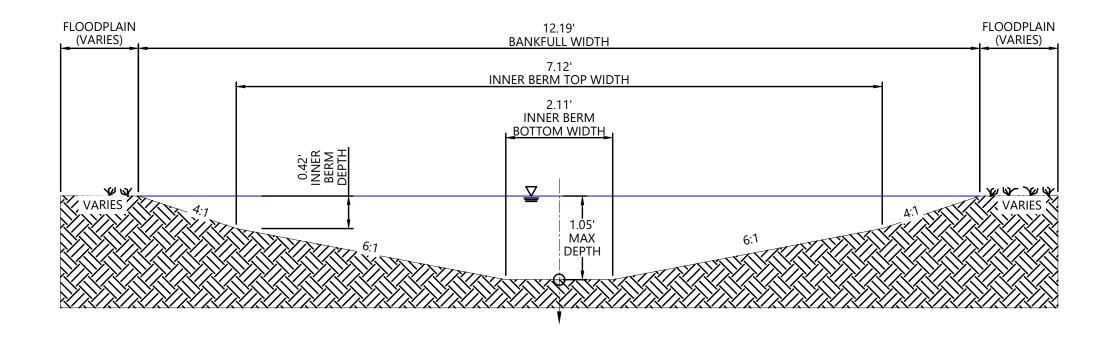

TYPICAL MAIN CHANNEL SECTION - POOL SCALE: NTS

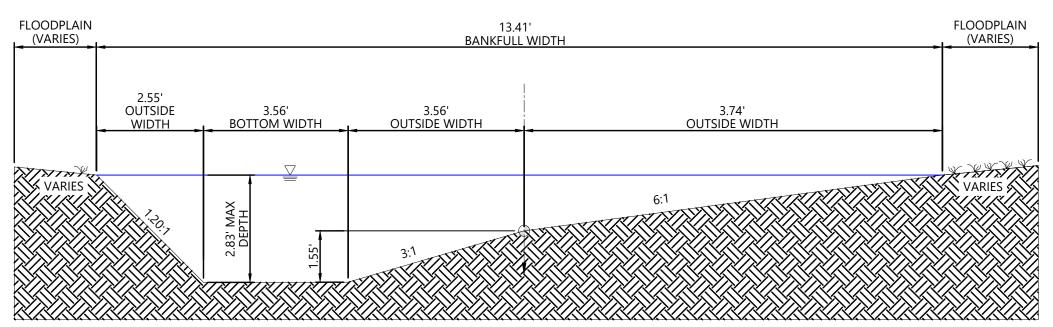

NOTES:

- 1. THALWEG (DEEPEST POINT IN A CROSS SECTION) IS LOCATED ON OUTSIDE 1/3 OF BANKFULL CHANNEL WITHIN THE POOL CROSS SECTION.
- 2. ALL CROSS SECTIONS ARE SHOWN LOOKING IN THE DOWNSTREAM DIRECTION.
- 3.

 GRADE POINT IS THE CENTERLINE OF THE STREAM.
- 4. $^{igstyle \cup}$ all sharp corners should be rounded.
- 5. THE ELEVATION OF THE LOCATION MARKED "INNER BERM DEPTH" SHALL MATCH THE DOWNSTREAM LOW FLOW ELEVATION.
- . CONTRACTOR TO WORK IN THE FIELD TO FIELD FIT RIFFLE AND POOL TRANSITIONS WITH THE ENGINEER AS NEEDED.



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90% DESIGN SUBMITTAL

Sheet Name

TYPICAL SECTION

2021013002

Custom

Sheet 32 of 66

- 1) BOULDERS SHALL BE PLACED AS SHOWN ON THE PLANS. LOCATION CAN BE MODIFIED DURING CONSTRUCTION AT THE DIRECTION OF ENGINEER.
- BOULDER STRUCTURES SHALL CONSIST OF A SURFACE BOULDER AND FOOTER BOULDER.
- SURFACE BOULDER SHALL BE PLACED ON TOP OF A FOOTER BOULDER AND HORIZONTALLY OFFSET (IN THE UPSTREAM DIRECTION) BY A DISTANCE OF $\frac{1}{2}$ THE BOULDER DIAMETER.

BANKFULL


CHANNEL

- THE SURFACE OF ALL BOULDERS SHALL BE SLIGHTLY ANGLED IN THE UPSTREAM DIRECTION SO THAT ACTIVE STREAM FLOW "PUSHES" THE SURFACE BOULDER ONTO THE SURFACE OF THE FOOTER BOULDER WITHOUT RESULTING IN SURFACE BOULDER SLIPPING OFF OF THE FOOTER BOULDER.
- BOULDERS DIAMETER = 2.0 FEET.

ENGINEER

SEE PLANS FOR

BOULDER PLACEMENT

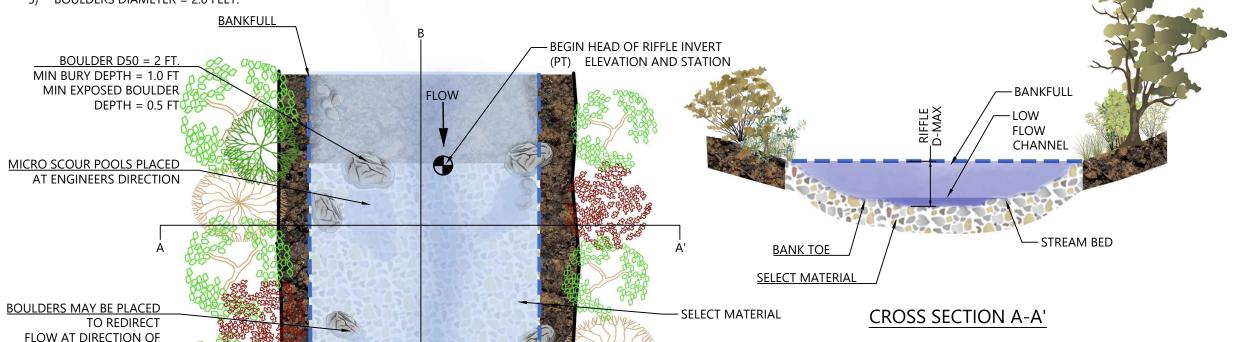


BEGIN TAIL OF RIFFLE INVERT

(PC) ELEVATION AND STATION

NOTES:

- SELECT RIFFLE MATERIAL WILL BE PLACED AT A UNIFORM THICKNESS.
- THE SELECT RIFFLE MATERIAL WILL BE PLACED SUCH THAT, IN CROSS-SECTION, ITS LOWEST ELEVATION OCCURS IN THE CENTER OF THE CHANNEL AS PER THE DETAIL.
- SET INVERTS AT ELEVATIONS SHOWN ON THE PROFILE.
- SELECT RIFFLE MATERIAL SHALL BE COMPACTED USING TRACK EQUIPMENT SUCH THAT FUTURE SETTLEMENT OF THE MATERIAL IS KEPT TO A MINIMUM.
- THE FINISHED GRADE SHALL MATCH TYPICAL RIFFLE CROSS-SECTION SHOWN ON THE DRAWINGS. THE INVERT ELEVATION TOLERANCE IS +/- 0.1 FT.
- POST INSTALLATION RE-DRESSING OF CHANNEL AND BANKFULL BENCH/FLOODPLAIN WILL LIKELY BE REQUIRED AND SHALL BE CONSIDERED INCIDENTAL TO CONSTRUCTION.
- SEE TYPICAL RIFFLE CROSS SECTION FOR DIMENSIONS.
- D= 2.0 FEET FOR ALL APPLICATIONS UNLESS OTHERWISE STATED.
- RIFFLE TYPE SHOWN ON THE PLANS.
- 10. SEE SPECIFICATIONS FOR FURTHER DETAIL.

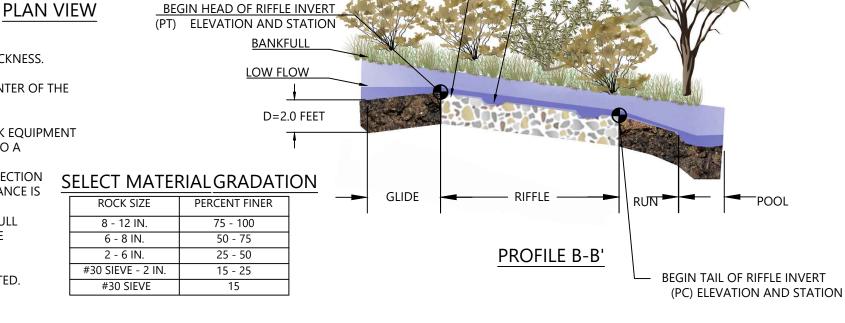

BID SET

SELECT MATERIAL

- MICRO SCOUR POOLS PLACED AT ENGINEERS DIRECTION



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STORMWATER

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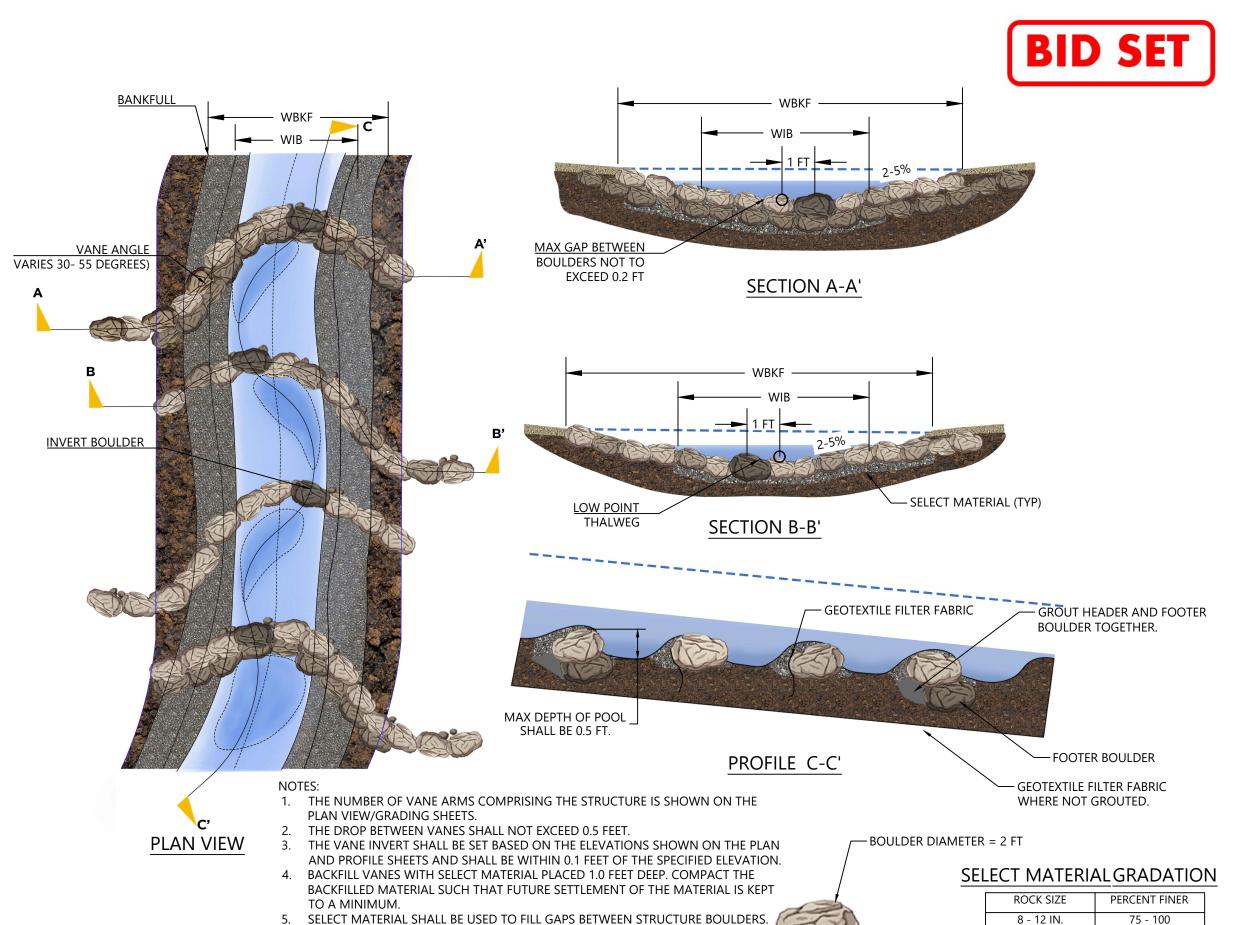
Sheet Name

COBBLE RIFFLE

2021013002

Custom

Sheet 33 of 66



HAND CHINK ROCK FROM THE BACK OF THE STRUCTURE AS NECESSARY.

SHOWN ON THE PROFILE.

ON THE DETAIL AND PROJECT PLANS. THE INVERT SHALL BE THE ELEVATION



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BOULDER RIFFLE

2021013002 Custom

Sheet 34 of 66

75 - 100 6 - 8 IN. 50 - 75 25 - 50 2 - 6 IN. #30 SIEVE - 2 IN. 15 - 25


THE INVERT OF THE BOULDER VANE IS OFFSET 1.0 FEET ALTERNATING AS SHOWN

8 - 12 IN.

#30 SIEVE 15



DIAGONALLY CUT WOOD STAKES MADE FROM 2"X4" DIMENSIONAL LUMBER 2'-0" LENGTHS FOR COIR MAT. PLACE STAKES 2' O.C.

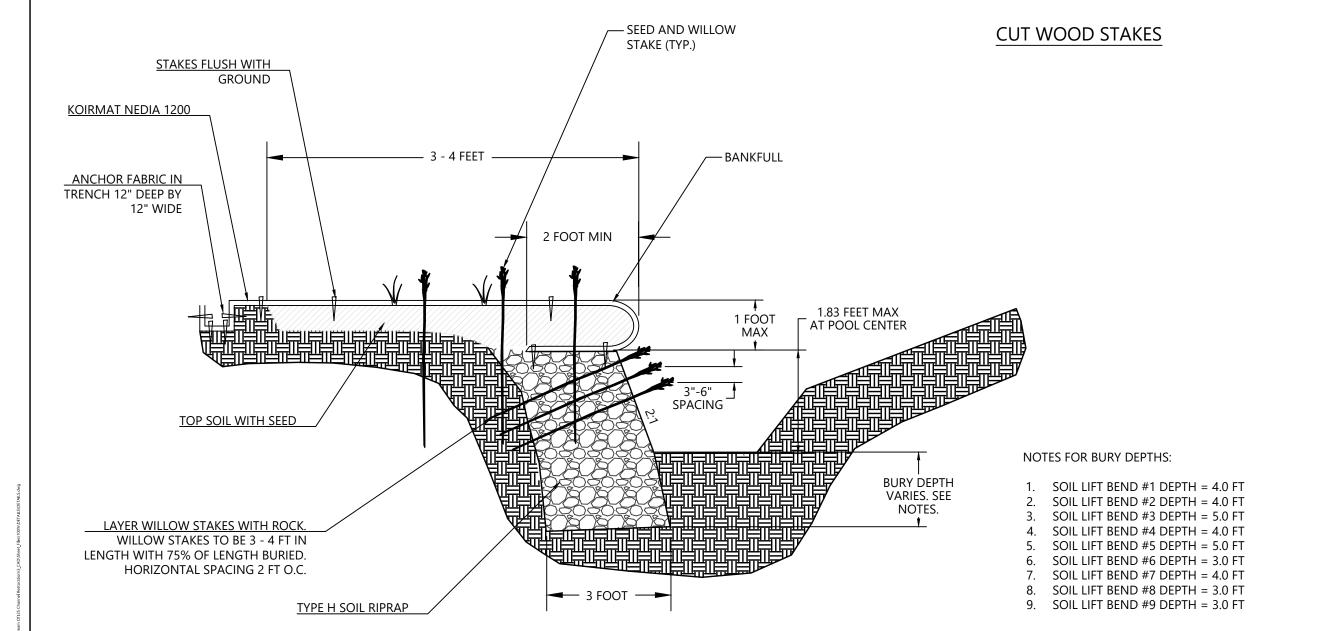

SOIL LIFT BEND SECTION



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SOIL LIFT WITH ROCK TOE

2021013002 Project No.

Custom

Sheet 35 of 66



DIAGONALLY CUT WOOD STAKES

MADE FROM 2"X4" DIMENSIONAL

LUMBER 2'-0" LENGTHS FOR COIR

MAT. PLACE STAKES 2' O.C.

2 FEET STAKES FLUSH WITH GROUND **CUT WOOD STAKES** KOIRMAT NEDIA 900 - SEED AND WILLOW STAKE 1 FT O.C. (TYP.) **ANCHOR FABRIC IN** TRENCH 6" DEEP BY – BANKFULL 3" WIDE 4 INCHES OF TOPSOIL AND EROSION
CONTROL BLANKET 2.50 FEET MAX AT POOL CENTER 3"-6" SPACING TOP SOIL WITH SEED NOTES: **BURY DEPTH** VARIES. SEE NOTES. 1. RIPRAP BANK #1 BURY DEPTH = 4.0 FT LAYER WILLOW STAKES WITH ROCK. 2. RIPRAP BANK #2 BURY DEPTH = 3.0 FT WILLOW STAKES TO BE 3 - 4 FT IN LENGTH WITH 75% OF LENGTH BURIED.

RIPRAP BANK SECTION

3 FOOT -

TYPE H SOIL RIPRAP



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RIPRAP BANK SECTION

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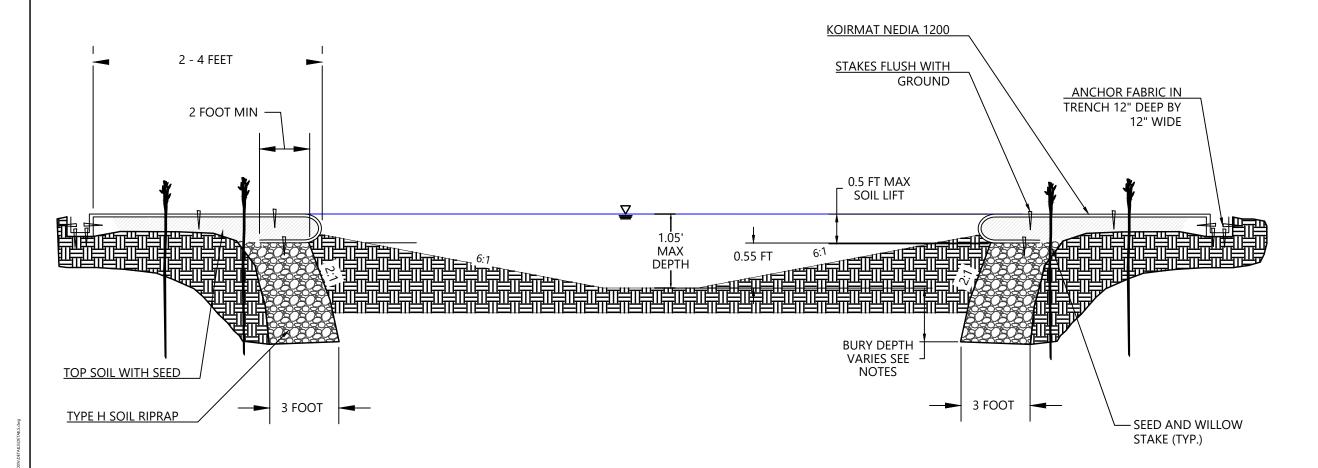
Sheet 36 of 66

ORIGINAL SHEET - ANS



DIAGONALLY CUT WOOD STAKES
MADE FROM 2"X4" DIMENSIONAL
LUMBER 2'-0" LENGTHS FOR COIR
MAT. PLACE STAKES 2' O.C.

CUT WOOD STAKES



NOTES:

- 1. RIFFLE SOIL LIFT #1 & #2 BURY DEPTH = 3.0 FT
- 2. RIFFLE SOIL LIFT #3 & #4 BURY DEPTH = 3.0 FT

RIFFLE SOIL LIFT SECTION



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SPRINGS



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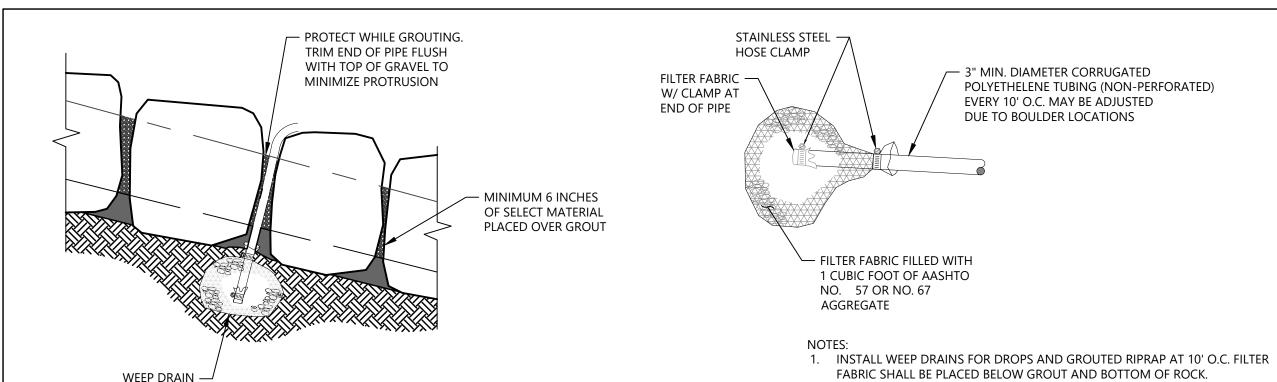
RIFFLE SOIL LIFT SECTION

2021013002 Project No.

Custom

Sheet 37 of 66


Matthew Johnson/WaterVation Dropbox 28 8:48 AM By: Matthew Johnson



GROUTED BOULDER DROP STRUCTURE

(SEE DETAIL)

WEEP DRAIN DETAIL

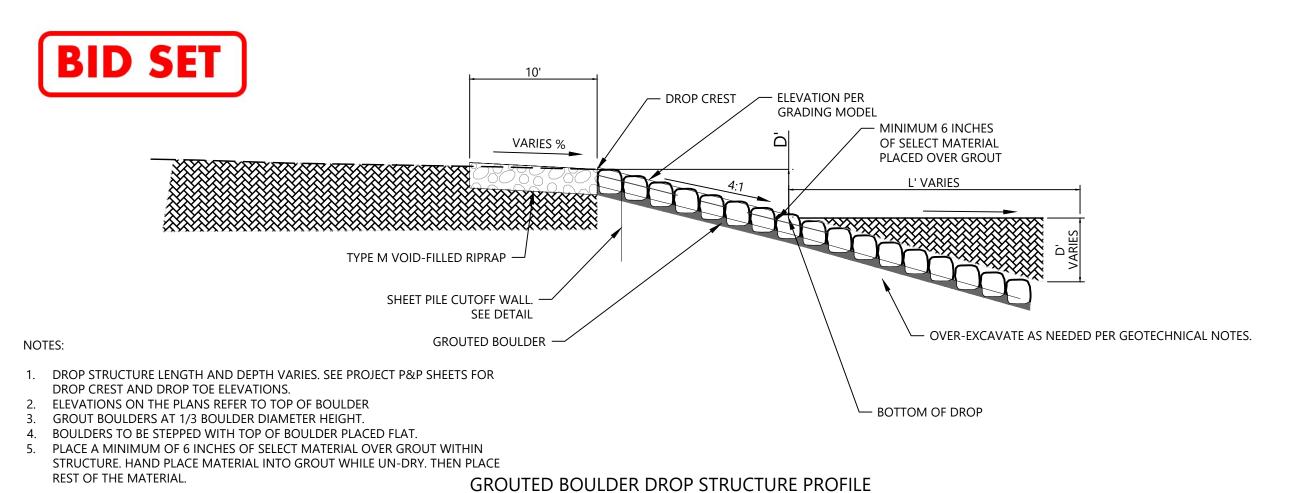



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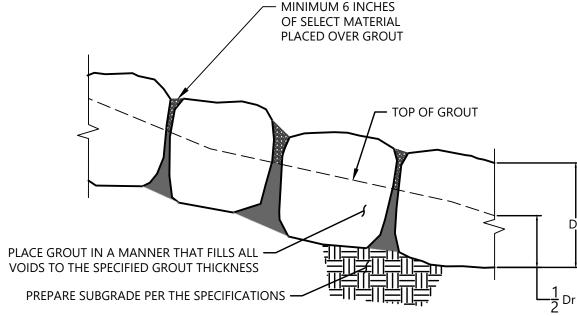
DROP STRUCTURE (1)

2021013002

Custom

Sheet 38 of 66

BID SET



BOULDER PLACEMENT NOTES:

- 1. PLACE BOULDER WITH THE REQUIRED BOULDER HEIGHT VERTICAL. PLACE BOULDERS AS TIGHTLY TOGETHER AS POSSIBLE (WITHOUT TOUCHING) WHILE PROVIDING ENOUGH ROOM BETWEEN THEM TO THOROUGHLY VIBRATE THE GROUT AND ENSURE NO GAPS IN THE GROUT. THE SMALL DIMENSION OF A 2X4 CAN BE USED AS A GUIDE TO CHECK MINIMUM SPACING.
- 2. BEFORE GROUTING, CLEAN ALL DIRT AND MATERIAL FROM ROCK THAT COULD PREVENT THE GROUT FROM BINDING THE TO ROCK. KEEP BOULDERS FROM TOUCHING. AVOID SLIDING BOULDERS AGAINST SUBGRADE TO PROPERLY POSITION.

MATERIALS SPECIFICATIONS:

- 1. ALL GROUT SHALL HAVE A MINIMUM 28-DAY COMPRESSIVE STRENGTH EQUAL TO
- ONE CUBIC YARD OF GROUT SHALL HAVE A MINIMUM OF SIX (6) SACKS OF TYPE II PORTLAND CEMENT.
- A MAXIMUM OF 25% TYPE F FLY ASH MAY BE SUBSTITUTED FOR THE PORTLAND
- THE AGGREGATE SHALL BE COMPRISED OF 70% NATURAL SAND (FINES) AND 30% ₹-INCH ROCK (COARSE).
- THE GROUT SLUMP SHALL BE BETWEEN 4-INCHES TO 6-INCHES. 5.
- AIR ENTRAINMENT SHALL BE BETWEEN 5.5% AND 7.5%.
- TO CONTROL SHRINKAGE AND CRACKING, 1.5 PONDS OF FIBERMESH, OR EQUIVALENT, SHALL BE USED PER CUBIC YARD OF GROUT.
- COLOR ADDITIVE IN REQUIRED AMOUNTS SHALL BE USED WHEN SO SPECIFIED BY CONTRACT.

GROUT PLACEMENT SPECIFICATIONS:

- 1. SPECIAL PROCEDURES SHALL BE REQUIRED FOR GROUT PLACEMENT WHEN THE AIR TEMPERATURES ARE LESS THAT 40°F OR GREATER THAN 90°F. CONTRACTOR SHALL OBTAIN PRIOR APPROVAL FROM THE DESIGN ENGINEER OF THE PROCEDURES TO BE USED FOR PROTECTING THE GROUT.
- GROUT SHALL BE DELIVERED BY MEANS OF A LOW PRESSURE (LESS THAN 10 PSI) GROUT PUMP USING A 2-INCH DIAMETER (MAXIMUM) NOZZLE.
- 3. FULL DEPTH PENETRATION OF THE GROUT INTO THE BOULDER VOIDS SHALL BE ACHIEVED BY INJECTING GROUT STARTING WITH THE NOZZLE NEAR THE BOTTOM AND RAISING IT AS THE GROUT FILLS, WHILE VIBRATING GROUT INTO PLACE USING A PENCIL VIBRATOR.
- 4. ALL GROUT BETWEEN BOULDERS SHALL BE TREATED WITH A BROOM FINISH.
- AFTER GROUT PLACEMENT, EXPOSED BOULDER FACES SHALL BE CLEANED AND FREE OF GROUT.
- ALL FINISHED GROUT SURFACES SHALL BE SPRAYED WITH A CLEAR LIQUID MEMBRANE CURING COMPOUND AS SPECIFIED IN ASTM C309.
- 7. PLACE SELECT MATERIAL OVER GROUT WHILE NOT DRY. MAY REQUIRE HAND PLACEMENT OF SELECT MATERIAL INTO WETTED GROUT.





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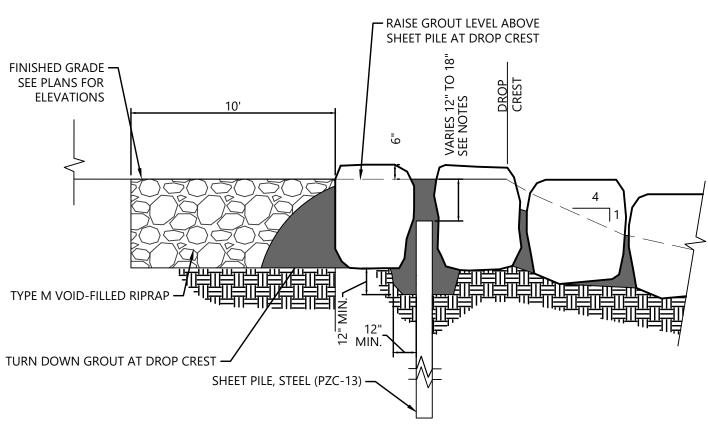
Sheet Name

DROP STRUCTURE (2)

2021013002 Project No.

Custom

Sheet 39 of 66



NOTES:

- UNDISTURBED GROUND

- 1. CREATE 7.12-FOOT WIDE LOW FLOW PATH CENTERED ON DROP STRUCTURE. GROUT DEPTH OVER SHEET PILE IS 12-INCHES AT LOW FLOW PATH AND 18-INCHES BEYOND THESE LIMITS.
- 2. SHEET PILE CUTOFF WALL TO BE PLACED BETWEEN THE FIRST AND SECOND BOULDER ROW OF THE DROP STRUCTURE.
- 3. CONTRACTOR TO MINIMIZE BOULDER SPACING GAP ALONG SHEET PILE.





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DROP STRUCTURE (3)

2021013002

STRUCTURE EDGE WALL DETAIL (GSB)

GROUTED

BOULDER

MINIMIZE

STRUCTURE CREST WALL DETAIL (GSB)

NTS

NTS

12" MIN


SOIL RIPRAP ·

GROUT CUTOFF WALL POURED IN TRENCH

BID SET

Custom

Sheet 40 of 66

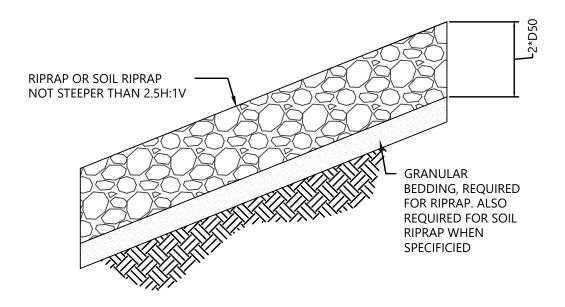

RIPRAP DESIGNATION	% SMALLER THAN GIVEN SIZE BY WEIGHT	INTERMEDIATE ROCK DIMENSION (INCHES)	D ₅₀ * (INCHES)
TYPE VL	70 - 100 50 - 70 35 - 50 2 - 10	12 9 6 2	6
TYPE L	70 - 100 50 - 70 35 - 50 2 - 10	15 12 9 3	9
TYPE M	70 - 100 50 - 70 35 - 50 2 - 10	21 18 12 4	12
ТҮРЕ Н	70 - 100 50 - 70 35 - 50 2 - 10	30 24 18 6	18
*D ₅₀ = MEAN ROCK SIZE			

RIPRAP AND SOIL RIPRAP PLACEMENT AND GRADATION

SOIL RIPRAP NOTES:

- 1. ELEVATION TOLERANCES FOR THE SOIL RIPRAP SHALL BE 0.10 FEET. THICKNESS OF SOIL RIPRAP SHALL BE NO LESS THAN THICKNESS SHOWN AND NO MORE THAN 2-INCHES GREATER THAN THE THICKNESS SHOWN.
- WHERE "SOIL RIPRAP" IS DESIGNATED ON THE CONTRACT DRAWINGS, RIPRAP VOIDS ARE TO BE FILLED WITH NATIVE SOIL. THE RIPRAP SHALL BE PRE-MIXED WITH THE NATIVE SOIL AT THE FOLLOWING PROPORTIONS BY VOLUME: 65 PERCENT RIPRAP AND 35 PERCENT SOIL. THE SOIL USED FOR MIXING SHALL BE NATIVE TOPSOIL AND SHALL HAVE A MINIMUM FINES CONTENT OF 15 PERCENT. THE SOIL RIPRAP SHALL BE INSTALLED IN A MANNER THAT RESULTS IN A DENSE, INTERLOCKED LAYER OF RIPRAP WITH RIPRAP VOIDS FILLED COMPLETELY WITH SOIL. SEGREGATION OF MATERIALS SHALL BE AVOIDED AND IN NO CASE SHALL THE COMBINED MATERIAL CONSIST PRIMARILY OF SOIL; THE DENSITY AND INTERLOCKING NATURE OF RIPRAP IN THE MIXED MATERIAL SHALL ESSENTIALLY BE THE SAME AS IF THE RIPRAP WAS PLACED WITHOUT SOIL.
- WHERE SPECIFIED (TYPICALLY AS "BURIED SOIL RIPRAP"), A SURFACE LAYER OF TOPSOIL SHALL BE PLACED OVER THE SOIL RIPRAP ACCORDING TO THE THICKNESS SPECIFIED ON THE CONTRACT DRAWINGS. THE TOPSOIL SURFACE LAYER SHALL BE COMPACTED TO APPROXIMATELY 85% OF MAXIMUM DENSITY AND WITHIN TWO PERCENTAGE POINTS OF OPTIMUM MOISTURE IN ACCORDANCE WITH ASTM D698. TOPSOIL SHALL BE ADDED TO ANY AREAS THAT SETTLE.
- 4. ALL SOIL RIPRAP THAT IS BURIED WITH TOPSOIL SHALL BE REVIEWED AND APPROVED BY THE ENGINEER PRIOR TO ANY TOPSOIL PLACEMENT.





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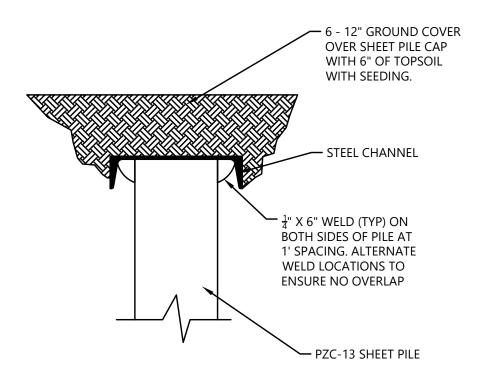
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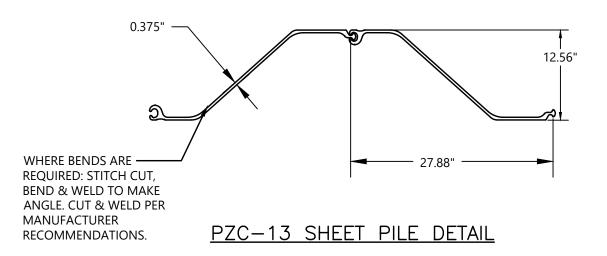
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Sheet Name RIPRAP


2021013002

Custom Project No.





STEEL SHEET PILE CAP

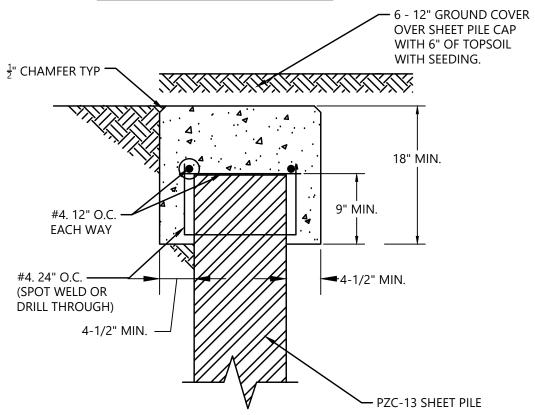

OPTIONAL ALTERNATIVE

CONCRETE PILE CAP



NOTES:

- 1. ADD CATHODIC PROTECTION 2 ANODES PER SHEET PILE, COORDINATE WITH CSU CATHODIC PROTECTION UNIT.
- 2. SHEET PILE CAP ONLY REQUIRED OUTSIDE GROUTED BOULDER AREA.



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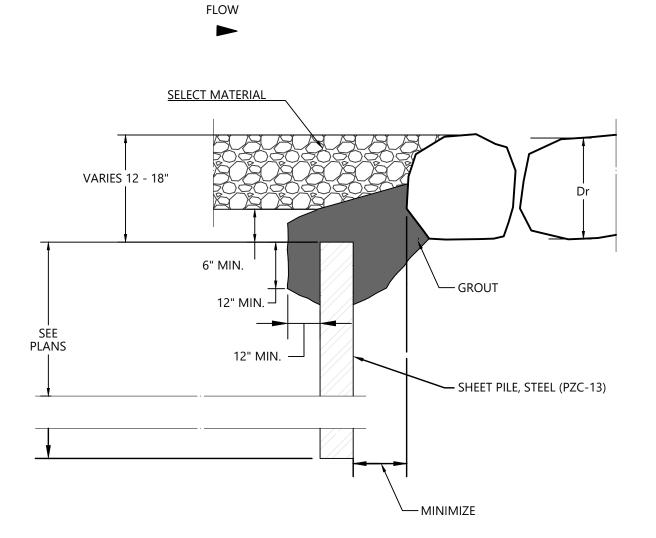
SHEET PILE CAP

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Sheet 42 of 66



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BOULDER RIFFLE SHEET PILE DETAIL

2021013002 Custom

Sheet **43** of **66**

BOULDER RIFFLE SHEET PILE DETAIL

GENERAL NOTES:

- 1. The contractor will supply all plants in quantities sufficient to complete the work shown on the plan. All plant material should meet the specifications of the American Standards for Nursery Stock (latest edition) as set forth by the American Association of Nurserymen.
- 2. All populations of Colorado List A and B noxious weeds found in or within 100 feet of the project area will be treated with the appropriate herbicide(s) prior to and throughout the duration of construction. Always follow all label recommendations, precautions and restrictions when using any herbicide. Read and comply with all herbicide labels, organic or nonorganic, for application rates, mixing instructions, protective equipment, re-entry period, grazing or harvest restrictions and other safety information. Herbicides should be applied only by responsible, licensed applicators.
- 3. After the site has been staked, but prior to clearing, grubbing, and earthwork activities, the contractor, engineer, and ecologist shall walk the site to evaluate and locate existing plant material to be protected and identify plant material that may be salvaged within the designated limits of construction.
- 4. The contractor will provide submittals for containerized plant material (wetland plugs and shrubs), all trees, each seed mix, mulch, and tackifier. Submittals for live plant material and the seed mixes will include the scientific names of each species, including variety and subspecies (as-applicable). Additionally, the seed mix submittals will include the lot number, test date, seed type and variety, purity and germination percentage, crop seed percentage, inert matter percentage, weed seed percentage, noxious weeds by name and number per pound.
- 5. All best management practices (BMPs) used shall be selected, installed, implemented, and maintained according to appropriate engineering, hydrologic and pollution control practices.
- 6. The use of chemicals such as soil stabilizers, dust palliatives, herbicides, growth inhibitors, fertilizers, deicing salts, etc., shall be in accordance with the manufacturer's recommended application rates, frequency, and instructions. These chemicals shall not be used, stored, or stockpiled within 50 horizontal feet of the creek or other aquatic habitats.
- Construction equipment, fuels, lubricants, and other petroleum distillates shall not be stored or stockpiled within 50 horizontal feet of the creek or other aquatic habitats. Equipment fueling and servicing shall occur only within approved designated areas.

TOPSOIL STOCKPILE NOTES:

- 1. The ecologist will oversee and inspect topsoil stockpiling activities.
- 2. Stockpile topsoil from wetlands separately in windrows, piles should be uncompacted and low in height with soil mounds no higher than 10 feet to preserve soil microbes and ideally no higher than 4 feet if space onsite allows.
- 3. Stockpile topsoil (separately from subgrade) from all other areas disturbed by the project in windrows, piles should be uncompacted and low in height with soil mounds no higher than 10 feet to preserve soil microbes and ideally no wider than 4 feet if space onsite allows.
- 4. Use a placard to identify stockpiles as "Wetland Topsoil", "Topsoil", or "Subgrade".
- 5. All topsoil stockpiled longer than 1 month should be seeded with Italian rye (*Lolium multifolorum*) at a rate of 2 lbs/1000 square feet.
- 6. Test all topsoil stockpiles for standard nutrient tests and USDA texture analysis and provide test results to the ecologist for review prior to application. Soil amendments may be adjusted based on these test results.
- 7. Prior to topsoil placement, the top one foot of the stockpile material should be mixed with the remainder of the stockpile to distribute living organisms.

SEEDBED PREPARATION NOTES:

- 1. The ecologist will oversee and inspect all seedbed preparation activities.
- 2. Do not work soils when frozen, snow covered, wet, or muddy.
- 3. Before topsoil is placed, sub-soil in all work areas (other than the immediate channel banks) will be decompacted and loosened to a depth of 12 inches.
- 4. Access roads and staging areas will be decompacted and loosened to a depth of 18 inches prior to topsoil placement.
- 5. When spreading topsoil, ensure that the layer is not compacted by using a soil penetrometer in general, penetrometer readings less than 200 pounds per square inch (psi) in the top 8 inches are appropriate. Contractor should place topsoil in a manner that precludes having to continuously drive over newly placed topsoil.
- Following topsoil placement, and before seeding and mulch application, topically apply organic slow release fertilizer (such as Biosol Forte) at 800 lbs. per acre to all disturbed non-wetland areas
- 7. All finished grades will be left rough and natural with soil clods no greater than 3 inches in diameter, no smooth surfaces or straight edges.

LIVE WILLOW STAKE HARVEST AND INSTALLATION NOTES:

- 1. Sandbar willow (*Salix exigua*) stakes can be harvested from within the limits of construction or other legally accessible sites nearby while dormant (Nov after leaf drop to April prior to bud break). All areas for harvest shall be approved by the ecologist prior to cutting and the ecologist will oversee the willow stake harvest operation.
- 2. When harvesting outside of the limits of constructioBEDn, remove no more than 20% of the branches from any single willow clump, do not remove more than 30% of the overall canopy cover from any willow stand and harvest stems evenly through the stand.
- 3. Stakes shall be approximately 3-feet in length and ½ to 1 inch diameter at the base. The stem shall be pruned of all branches with the bottom end cut at a 45-degree angle and the top end cut at a 90-degree angle.
- 4. As stakes are cut, the bottom end shall be immediately placed into water. Once harvested, stakes shall be completely submerged in cold water--for at least 72 hours, but not more than 14 days, prior to planting. The storage location shall be shaded to maintain a cold-water temperature. The stakes will be kept wet until placed into the ground and will not be stored out of water for more than 10 minutes prior to planting.
- 5. Willow stakes will be installed from 0.5 to 2.5 feet vertical above the low-flow water surface elevation.
- 6. Stake spacing shall be 1.5-foot on center, located in upper Zone A and all of Zone B. Stakes shall be installed to a depth of 24-inches ensuring that the bottom end is placed in or at the top of the water table.
- 7. Backfill willow stake holes to remove any air pockets and trim all installed stakes to no more than 8 inches above the ground surface.







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CHANNEL RESTORATION COLORADO SPRINGS, CO

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REVEGETATION NOTES (1)

2021013002

Project No. Horizontal Scale

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Sheet **44** of **66**


CONTAINERIZED PLANT MATERIAL INSTALLATION NOTES:


- 1. All containerized plant material must be inspected for health, size, species, and quantity upon arrival onsite, notify the ecologist at least 3 business days prior to delivery. Alternatively, local nursery inspection of plants may be arranged prior to delivery. Please notify the ecologist at least 3 business days prior to scheduled delivery.
- All plant material should be watered prior to transport and covered during transport. Water plant material once it arrives onsite and store in a shaded location or in the Middle Tributary channel if water levels allow.
- Zone A is 0-1.5 vertical feet, Zone B is 1.5-2.5 vertical feet, Zone C is 2.5-4.5 vertical feet and Zone D is anything above 4.5 vertical feet above the low-flow water surface elevation, as shown in the project plans. Exact planting locations will be based on final grading.
- The contractor will mark all planting locations for adjustment and approval by the ecologist prior to installation.
- When installing trees and shrubs, dig the hole 1.5 to 2 times the width of the rootball.
- Tree and shrubs planted in Zones B and C shall be deep planted, when necessary and as plant material size allows to ensure placement of the rootball in the capillary fringe (moist soil) immediately above the water table. Trees and shrubs can be planted up to 1/3 to 1/2 of the above ground height at the time of planting.
- Create watering dishes for all trees and shrubs (except willow stakes). All 60 cubic inch (ci) shrubs and 5-gallon trees, watering dishes shall be 3 inches deep by 2 feet in diameter.
- Once planted, all trees and shrubs shall be watered so that the entire rootball and soil around the rootball are inundated. Water thoroughly on the day of planting.

SEEDING AND MULCHING NOTES:

- 1. No construction equipment will be allowed in the project area after seeding.
- All seed bags found onsite should be tagged and labeled. Seed bag tags should have the following information; project Name, total pounds, and the scientific names and seeding rate for each species.
- The contractor will stake the seeding limits and obtain approval from the ecologist prior to seeding.
- Seeding will only be performed in late September or early October, unless approved by the
- All areas in Zone A (0-1.5 vertical feet) will be seeded with the Wetland Seed Mix (Table 2), Zone B will be seeded with the Wetland and Riparian and Upland Seed Mixes (Tables 2 and 3), and Zones C and D will be seeded with the Riparian and Upland Seed Mix (Table 3).
- Seeding rates shown in the tables are for drill seeding, double the rate for broadcast seeding. Drill seeding is the preferred seeding method where terrain allows.
- 7. All bank treatments will be seeded with the Wetland and Riparian Seed Mixes (Tables 2 and 3)
- All areas with erosion control blanket will be decompacted and a loose, smooth seed bed prepared using rakes and other hand tools. Prior to blanket placement, broadcast seed the appropriate mix based on the planted zone at the specified rate shown in Tables 2, 3, or 4.
- 9. Adjacent seed mixes will be overlapped by each other a minimum of 3 feet.
- 10. After seeding, all areas that lack erosion control blanket will be hydromulched with mechanically defibrated virgin wood fiber at a rate of 2,500 lbs/acre with 150 lbs/acre of organic psyllium derived tackifier.



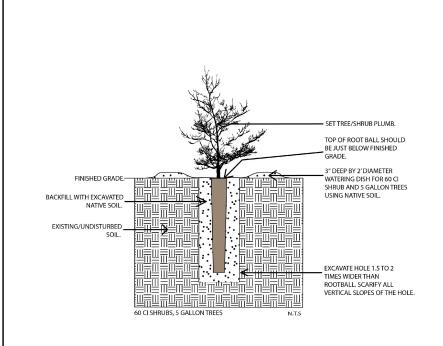

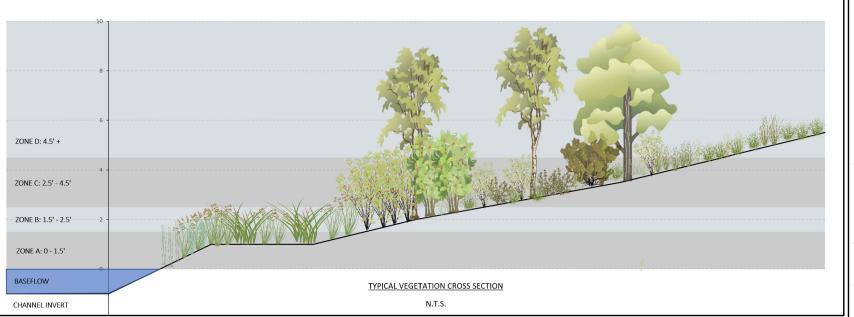





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REVEGETATION NOTES (2)

2021013002

Project No

Sheet 45 of 66

WETLAND AND RIPARIAN CONTAINERIZED PLANT MATERIAL:

Common Name	Scientific Name	Size	Spacing (O.C.)	Quantity	
Zone A ¹					
Nebraska Sedge	Carex nebrascensis	10 ci	1.5'	1,000	
Hardstem Bulrush	Schoenoplectus acutus	10 ci	1.5'	750	
Common Threesquare	Schoenoplectus pungens	10 ci	1.5'	1,000	
Softstem Bulrush	Schoenoplectus tabernaemontani	10 ci	1.5'	750	
Wooly Sedge	Carex pellita 10 ci 1.5'		1.5'	2,000	
Common Spikerush	Eleocharis palustris	10 ci	1.5'	1,000	
Panicled Bulrush	Scirpus microcarpus	10 ci	1.5'	1,000	
Baltic Rush	Juncus balticus	10 ci	1.5'	1,000	
Willow Stakes	Salix exigua	3-foot stake	1.5'	4,250	
			Total Zone A	12,750	
Zone B ¹					
Narrowleaf Cottonwood	Populus angustifolia	5-gal	10'	30	
Peachleaf Willow	Salix amygdaloides	5-gal	10'	10	
Redosier Dogwood	Cornus sericea	60 ci	3'-4'	100	
American Plum	Prunus americana	60 ci	3'-4'	125	
Chokecherry	Prunus virginiana	60 ci	3'-4'	100	
Willow Stakes	Salix exigua	3-foot stake	1.5'	850	
			Total Zone B	1,215	
Zone C ¹					
Narrowleaf Cottonwood	Populus angustifolia	5-gal	10'	10	
Golden Currant	Ribes aurem	60 ci	3'-4'	25	
Woods' Rose	Rosa woodsii	60 ci	3'-4'	27	
Western Snowberry	Symphoricarpos occidentalis	60 ci	3'-4'	30	
			Total Zone C	92	
Live Willow Stakes, When	re Specified				
Sandbar Willow	Salix exigua	3-foot Stake	1.5'	400	
	•				

UPLAND SEED MIX (ZONE D):

Common Name	Scientific Name	Variety	Lbs PLS/Acre ¹
Indian Ricegrass	Achnatherum hymenoides	Native	2.0
Fringed sage	Artemisia frigida	Native	0.1
Sideoats grama	Bouteloua curtipendula	Vaughn	0.7
blue grama	Bouteloua gracilis	Lovington	0.3
blue grama	Bouteloua gracilis	Hachita	0.3
Buffalograss	Buchloe dactyloides	Bowie	3.8
Buffalograss	Buchloe dactyloides	Cody	3.8
Prairie sandreed	Calamovilfa longifolia	Goshen	1.0
Purple Prarie Clover	Dalea purpurea	Native	0.3
Thickspike wheatgrass	Elymus lanceolatus ssp. lanceolatus	Critana	1.8
Blanketflower	Gaillardia aristata	Native	0.4
needle and thread grass	Hesperostipa comata ssp. comata	Native	2.5
sidebells penstemon	Penstemon secundiflorus	Native	0.1
Prairie coneflower	Ratibida columnifera	Native	0.1
Little bluestem	Schizachyrium scoparium	Cimarron	0.5
Sand dropseed	Sporobolus cryptandrus	Native	0.1
	-	Total	17.8

WETLAND AND RIPARIAN SEED MIX (ZONES A & B & C):

Common Name	Scientific Name	Variety	NWPL ¹ Indicator	Lbs PLS/Acre ²	
Prairie Cordgrass	Spartina pectinata	VNS	FACW	2	
Switchgrass	Panicum virgatum	Blackwell, Dacotah, or NE 28	FAC	1.2	
Canada Wildrye	Elymus canadensis	Mandan	FACU	2.3	
Western Wheatgrass	Pascopyrum smithii	Rosana, Arriba	FACU	3.5	
Fowl Mannagrass	Glyceria striata	VNS	OBL	2.5	
Sand Dropseed	Sporobolus cryptandrus	VNS	FACU	1	
Green Needlegrass	Nassella viridula	Lodorm, Cucharas Germplasm	UPL	1.5	
Alkali Sacaton	Sporobolus airoides	Native	FAC	0.1	
Buffalograss	Bouteloua dactyloides	Tatanka	UPL	3	
Softstem Bulrush	Schoenoplectus tabernaemontani	Native	OBL	0.7	
Common Threesquare	Schoenoplectus pungens	Native	OBL	1	
Baltic Rush	Juncus balticus	Native	FACW	0.1	
Creeping Spikerush	Eleocharis palustris	Native	OBL	0.5	
Swamp Milkweed	Asclepias incarnata	Native	FACW	0.1	
Prairie Coneflower	Ratibida columnifera	Native	UPL	0.3	
Blue Flax	Linum lewisii	Native	UPL	1.2	
Purple Prairiecover	Dalea purpurea	Purpurea	UPL	0.8	
Threeleaf Sumac	Rhus trilobata	Native	UPL	2	
Wood's Rose	Rosa woodsii	Native	UPL	1	
Fringed Sage	Artemisia frigida	Native	UPL	1	
Mountain Mohogany	Cercocarpus ledifolius	Native	UPL	2	
	•	•	Total	27.8	

BID SET

VEGETATIVE STRIPS):

Common Name	Scientific Name	Size	Spacing (O.C.)	Quantity
Vegetative Strips				
Golden Currant	Ribes aurem	60 ci	1.5'	42
Woods' Rose	Rosa woodsii	60 ci	1.5'	42
Redosier Dogwood	Cornus sericea	60 ci	1.5'	42
Chokecherry	Prunus virginiana	60 ci	1.5'	42
Willow Stakes	Salix exigua	3-foot stake	1.5'	42
			Total for Strips	210

NOTES:

- 1. ZONE A IS 0 1.5 VERTICAL FEET ABOVE THE LOW FLOW CHANNEL
- 2. ZONE B IS 1.5 2.5 VERTICAL FEET ABOVE THE LOW FLOW CHANNEL
- 3. ZONE C IS 2.5 4.5 VERTICAL FEET ABOVE THE LOW FLOW CHANNEL
- 4. ZONE D IS ANYTHING ABOVE 4.5 VERTICAL FEET ABOVE THE LOW FLOW CHANNEL
- 5. LBS PLS/ACRE IS BASED ON DRILL SEEDING, DOUBLE THIS RATE IF BROADCAST SEEDING
- 6. NWPL = NATIONAL WETLAND PLANT LIST



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Sheet Name

REVEGETATION NOTES (3)

2021013002

Project No.

Horizontal Scale

Sheet **46** of **66**

		Upland Seed Mix				
Scientific Name and Variety	Variety*	Common Name	PLS lbs/ac	% of Seed Mix by Wgt	PLS/sq ft	% of PLS/sq
Graminoids						
Achnatherum hymenoides	Paloma	Indian ricegrass	1.50	5	5	
Bouteloua curtipendula	Butte or Vaughn	sideoats grama	3.50	11	15	
Bouteloua gracilis	CO Ecotype (or VNS)	blue grama	1.00	3	19	
Schizachyrium scoparium	Aldous	little bluestem	1.20	4	6	
Elymus lanceolatus ssp. lanceolatus	CO Ecotype (or VNS)	thickspike wheatgrass	3.50	11	12	
Festuca idahoensis	Elmer	Idaho fescue	1.00	3	10	
Hesperostipa comata	Paloma	needle and thread	2.00	6	5	
Koeleria macrantha	CO Ecotype (or VNS)	prairie junegrass	0.15	0	8	
Pascopyrum smithii	Rosana	western wheatgrass	3.00	9	8	
Poa secunda	CO Ecotype (or VNS)	Sandberg bluegrass	0.50	2	12	
Sporobolus cryptandrus	CO Ecotype (or VNS)	sand dropseed	0.14	0	18	
Triticum aestivum x Secale cereale	VNS	Quickguard sterile hybrid tritical	10.00	31	3	
		Graminoid Totals	27	85	121	
Forbs						
Achillea lanulosa var occidentalis	Eagle or Yakima	common yarrow	0.05	0	4	
Gaillardia aristata	CO Ecotype (or VNS)	blanketflower	1.00	3	4	
Penstemon secundiflorus	CO Ecotype (or VNS)	sidebells penstemon	0.40	1	5	
Ratibida columnifera	CO Ecotype (or VNS)	prairie coneflower	0.30	1	5	
Solidago canadensis	CO Ecotype (or VNS)	Canada goldenrod	0.05	0	5	
		Forb Totals	1.80	6	23	
Shrub/Sub-Shrub						
Artemisia frigida	CO Ecotype (or VNS)	fringed sage	0.05	0	5	
Cercocarpus ledifolius	CO Ecotype (or VNS)	curl-leaf mountain mahogany	3.00	9	4	
Artemisia ludoviciana	CO Ecotype (or VNS)	prairie sage	0.05	0	5	
		Shrub/Sub-Shrub Totals	3.10	10	14	
		Total	32.39	100	158	1





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REVEGETATION NOTES (4)

2021013002

Project No.

Horizontal Scale

Sheet **47** of **66**

		Riparian Seed Mix				
Scientific Name and Variety	Variety*	Common Name	PLS lbs/ac	% of Seed Mix by Wgt	PLS/sq ft	% of PLS/sq ft
Graminoids						
Agrostis scabra	CO Ecotype (or VNS)	ticklegrass	0.08	0	9	
Juncus arcticus ssp. Littoralis	CO Ecotype (or VNS)	mountain rush	0.04	0	10	
Elymus canadensis	Mandan	Canada wildrye	4.00	9	10	
Elymus lanceolatus ssp. lanceolatus	Critana	thickspike wheatgrass	4.00	9	14	1
Elymus trachycaulus	San Luis	slender wheatgrass	2.70	6	10	
Panicum virgatum	Forestburg	switchgrass	1.50	3	9	
Pascopyrum smithii	Rosana	western wheatgrass	4.00	9	10	
Poa palustris	CO Ecotype (or VNS)	fowl bluegrass	0.20	0	9	
Sporobolus airoides	Salado	alkali sacaton	0.20	0	8	I
Sporobolus cryptandrus	CO Ecotype (or VNS)	sand dropseed	0.08	0	10	
Triticum aestivum x Secale cereale	VNS	Quickguard sterile hybrid tritical	10.00	21	3	
		Graminoid Totals	26.80	57	103	7
Forbs						
Solidago canadensis	CO Ecotype (or VNS)	Canada goldenrod	0.07	0	7	
Vicia americana	CO Ecotype (or VNS)	American vetch	5.00	11	4	
Geranium viscosissimum	Incisum	sticky geranium	6.20	13	7	
Asclepias tuberosa ssp. Interior	CO Ecotype (or VNS)	butterfly milkweed	2.20	5	5	
		Forb Totals	13.47	29	24	18
Shrubs / Sub-Shrub			•			
Rhus trilobata	CO Ecotype (or VNS)	threeleaf sumac	4.00	9	2	,
Fallugia paradoxa	CO Ecotype (or VNS)	Apache plume	0.40	1	4	,
Rosa woodsii	CO Ecotype (or VNS)	Wood's rose	2.20	5	3	
		Shrubs/Sub-Shrub Totals	6.60	14	9	
		Tota	46.87	100	136	10





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Sheet Name

REVEGETATION NOTES (5)

2021013002

Project No.

Horizontal Scale

Sheet **48** of **66**

		Wetland Seed Mix					
Scientific Name and Variety	Variety*	Common Name		PLS lbs/ac	% of Seed Mix by Wgt	PLS/sq ft	% of PLS/sq ft
Graminoids							
Carex nebrascensis	CO Ecotype (or VNS)	Nebraska sedge		1.00	6	10	8
Elymus canadensis	Mandan	Canada wildrye		4.50	29	12	Ş
Elymus trachycaulus	San Luis	slender wheatgrass		3.00	19	11	9
Juncus arcticus ssp. Littoralis	CO Ecotype (or VNS)	mountain rush		0.04	0	10	
Juncus torreyi	CO Ecotype (or VNS)	Torrey's rush		0.30	2	9	8
Panicum virgatum	Forestburg	switchgrass		2.00	13	12	č
Poa palustris	CO Ecotype (or VNS)	fowl bluegrass		0.25	2	11	9
Schoenoplectus acutus	CO Ecotype (or VNS)	hardstem bulrush		0.80	5	8	6
Schoenoplectus tabernaemontani	CO Ecotype (or VNS)	softstem bulrush		0.70	4	9	7
Sporobolus airoides	Salado	alkali sacaton		0.25	2	10	8
			Graminoid Totals	12.84	82	102	63
Forbs							
Helianthus nuttallii	CO Ecotype (or VNS)	Nuttall's sunflower		0.34	2	. 2	1
Verbena hastata	CO Ecotype (or VNS)	swamp verbena		0.52	3	19	15
Asclepias incarnata	CO Ecotype (or VNS)	swamp milkweed		1.87	12	3	2
			Forb Totals	2.73	18	24	19
	-		Total	15.57	100	126	100
*vns. = variety not specified							





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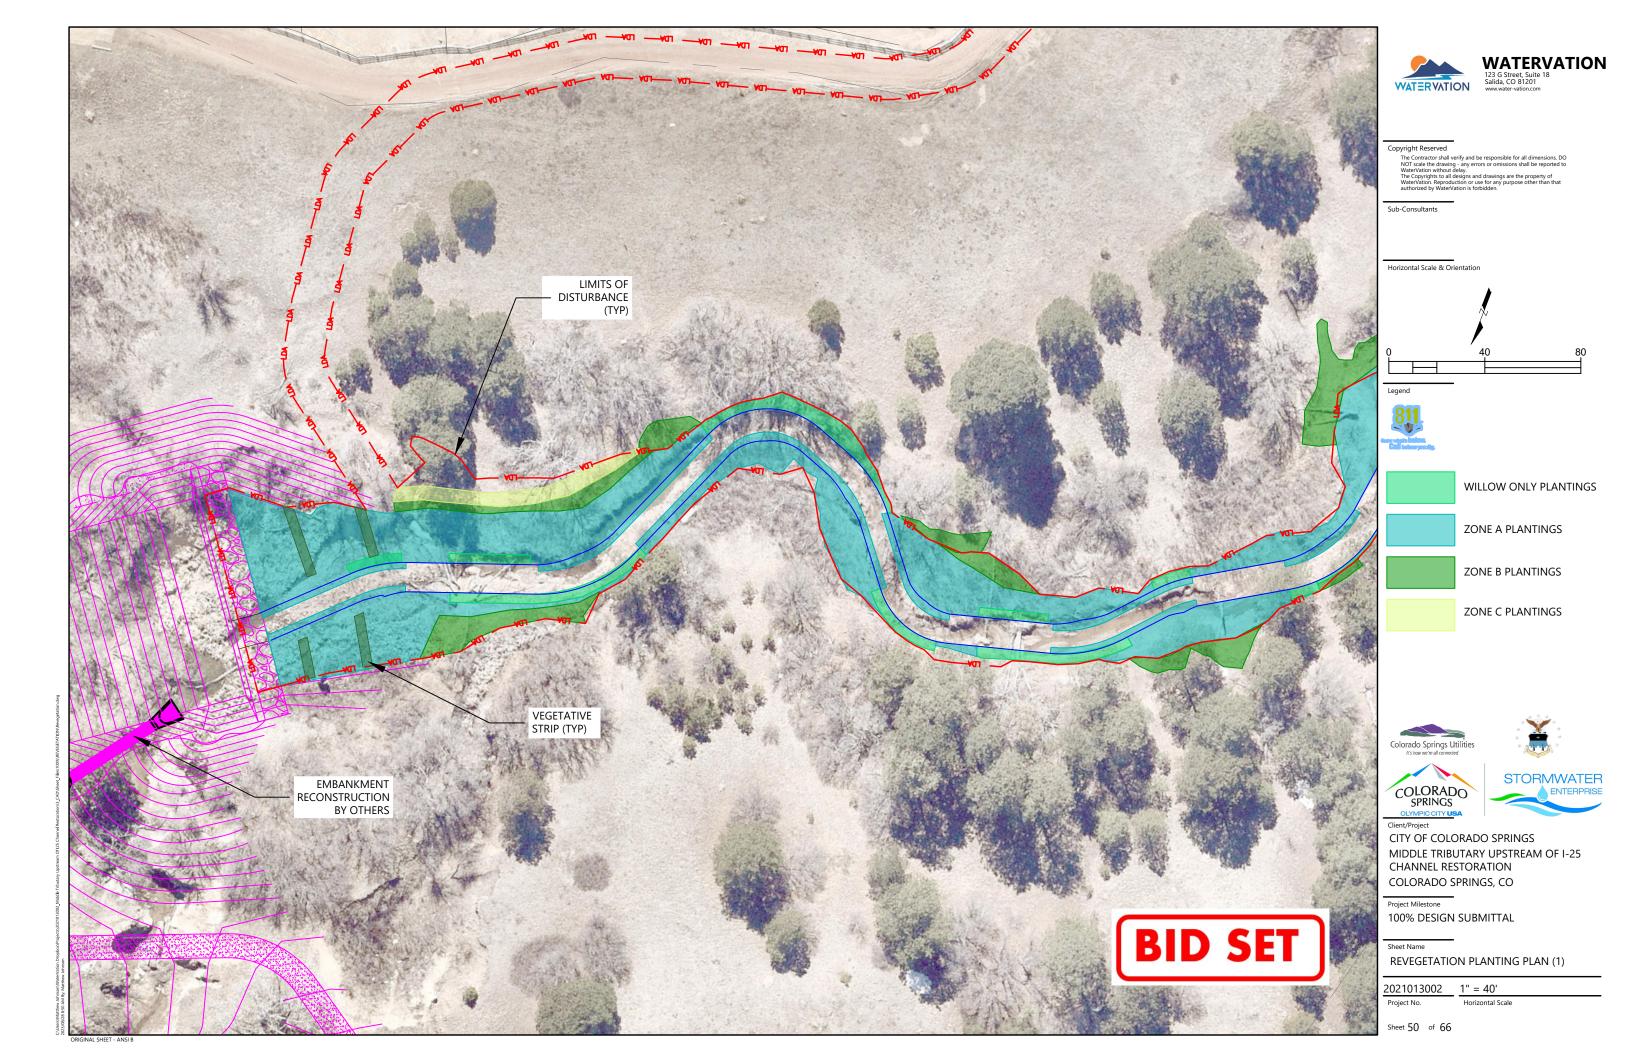
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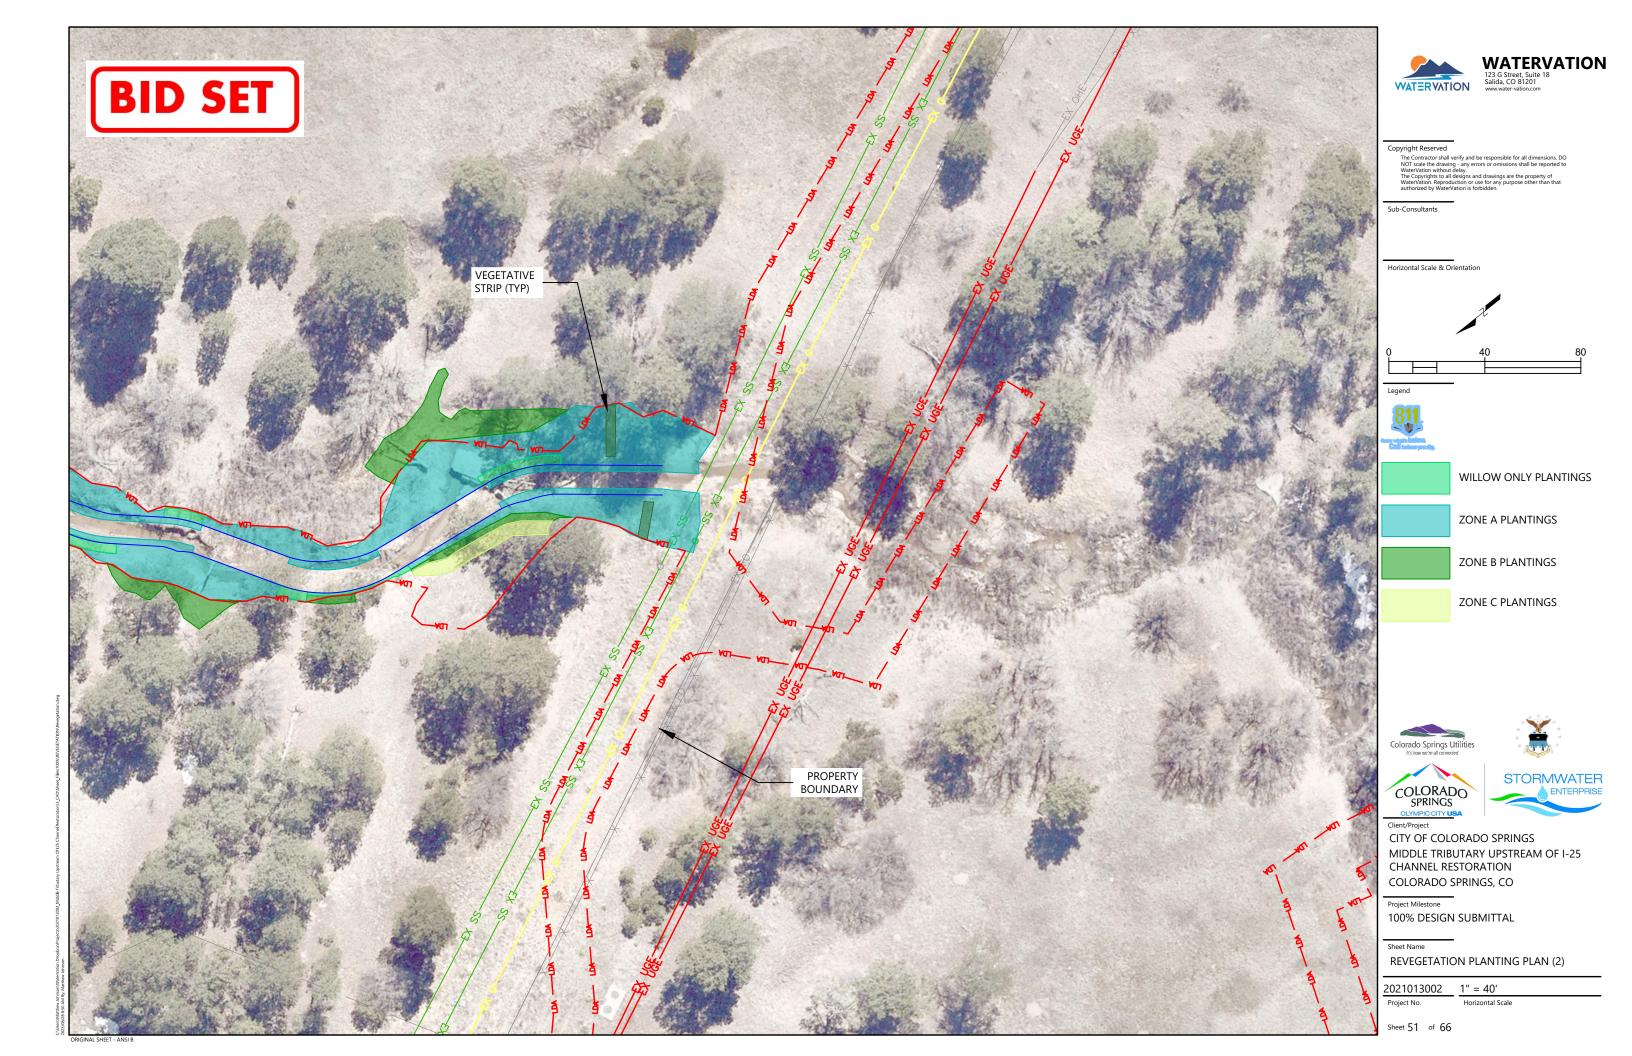
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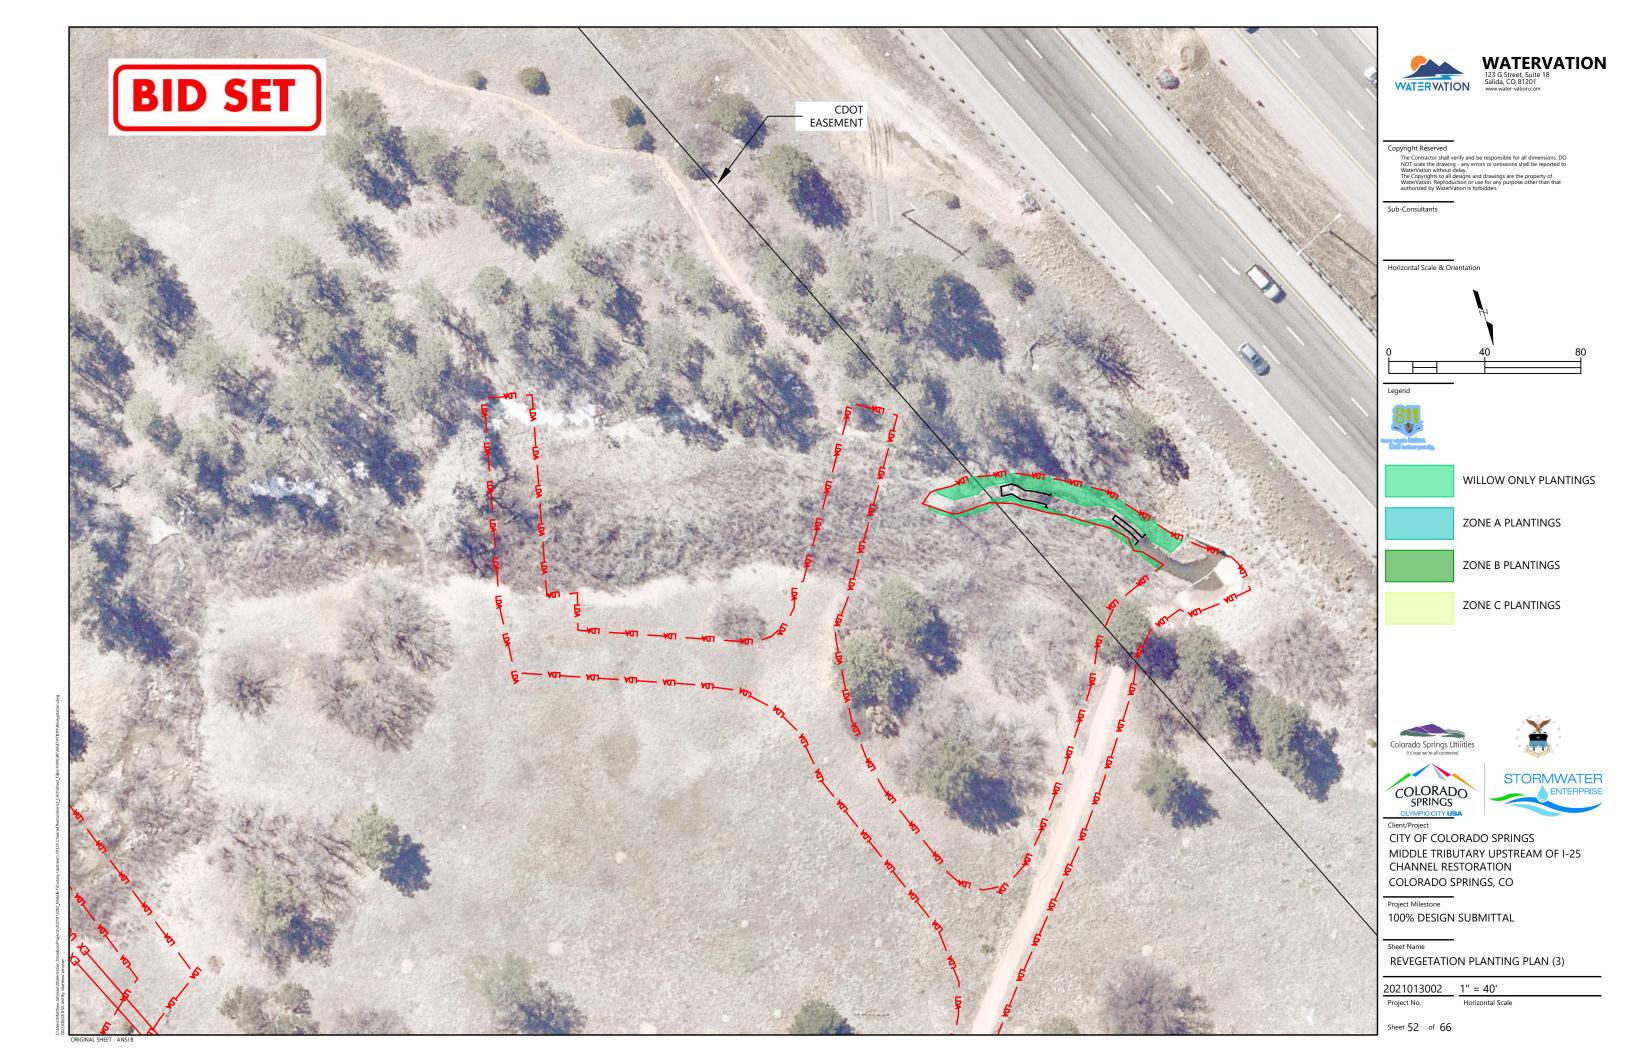
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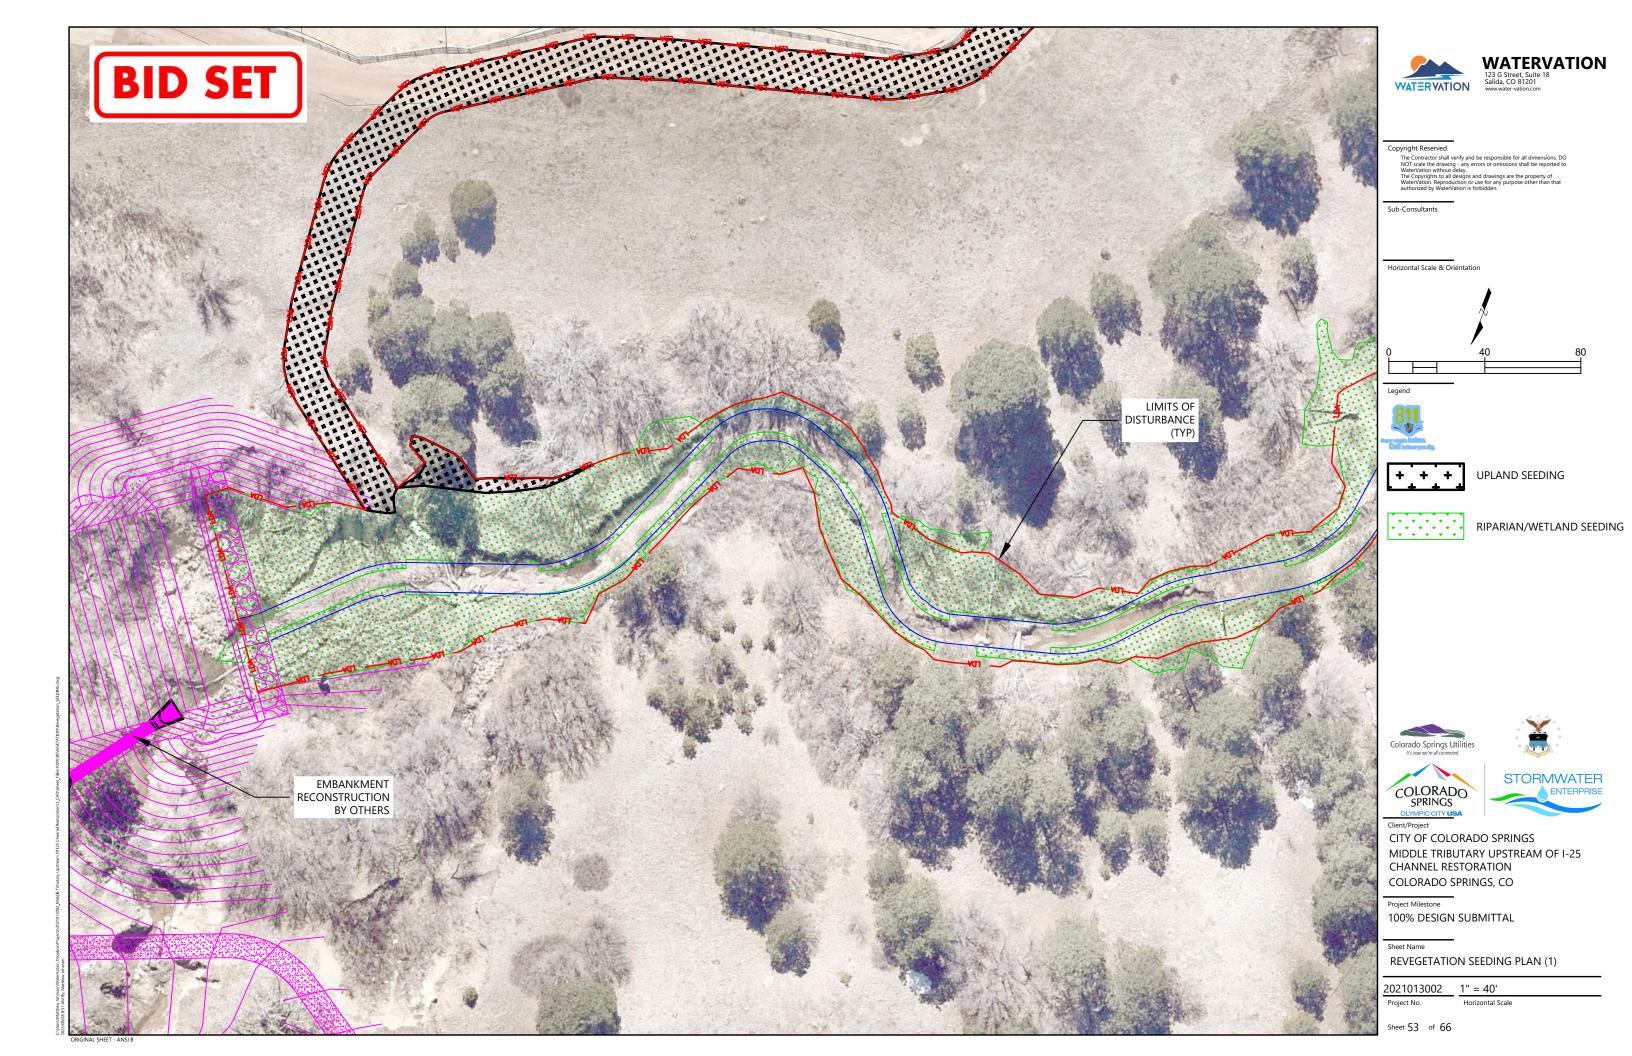
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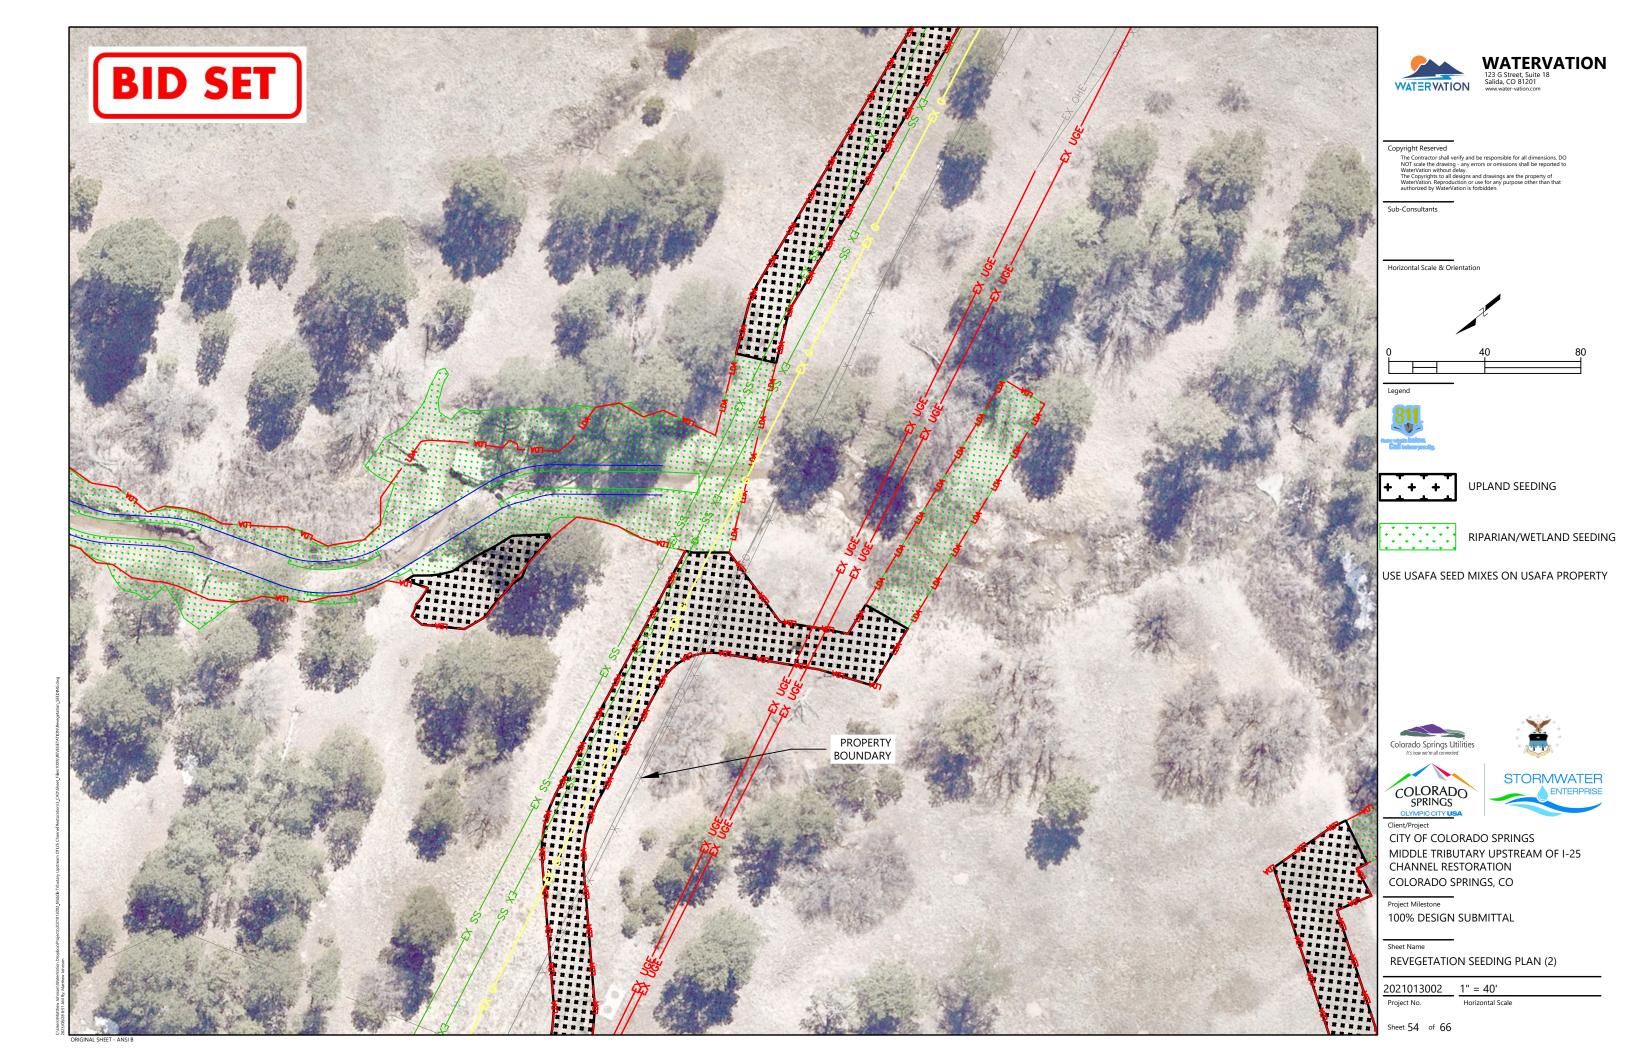
Sheet **49** of **66**













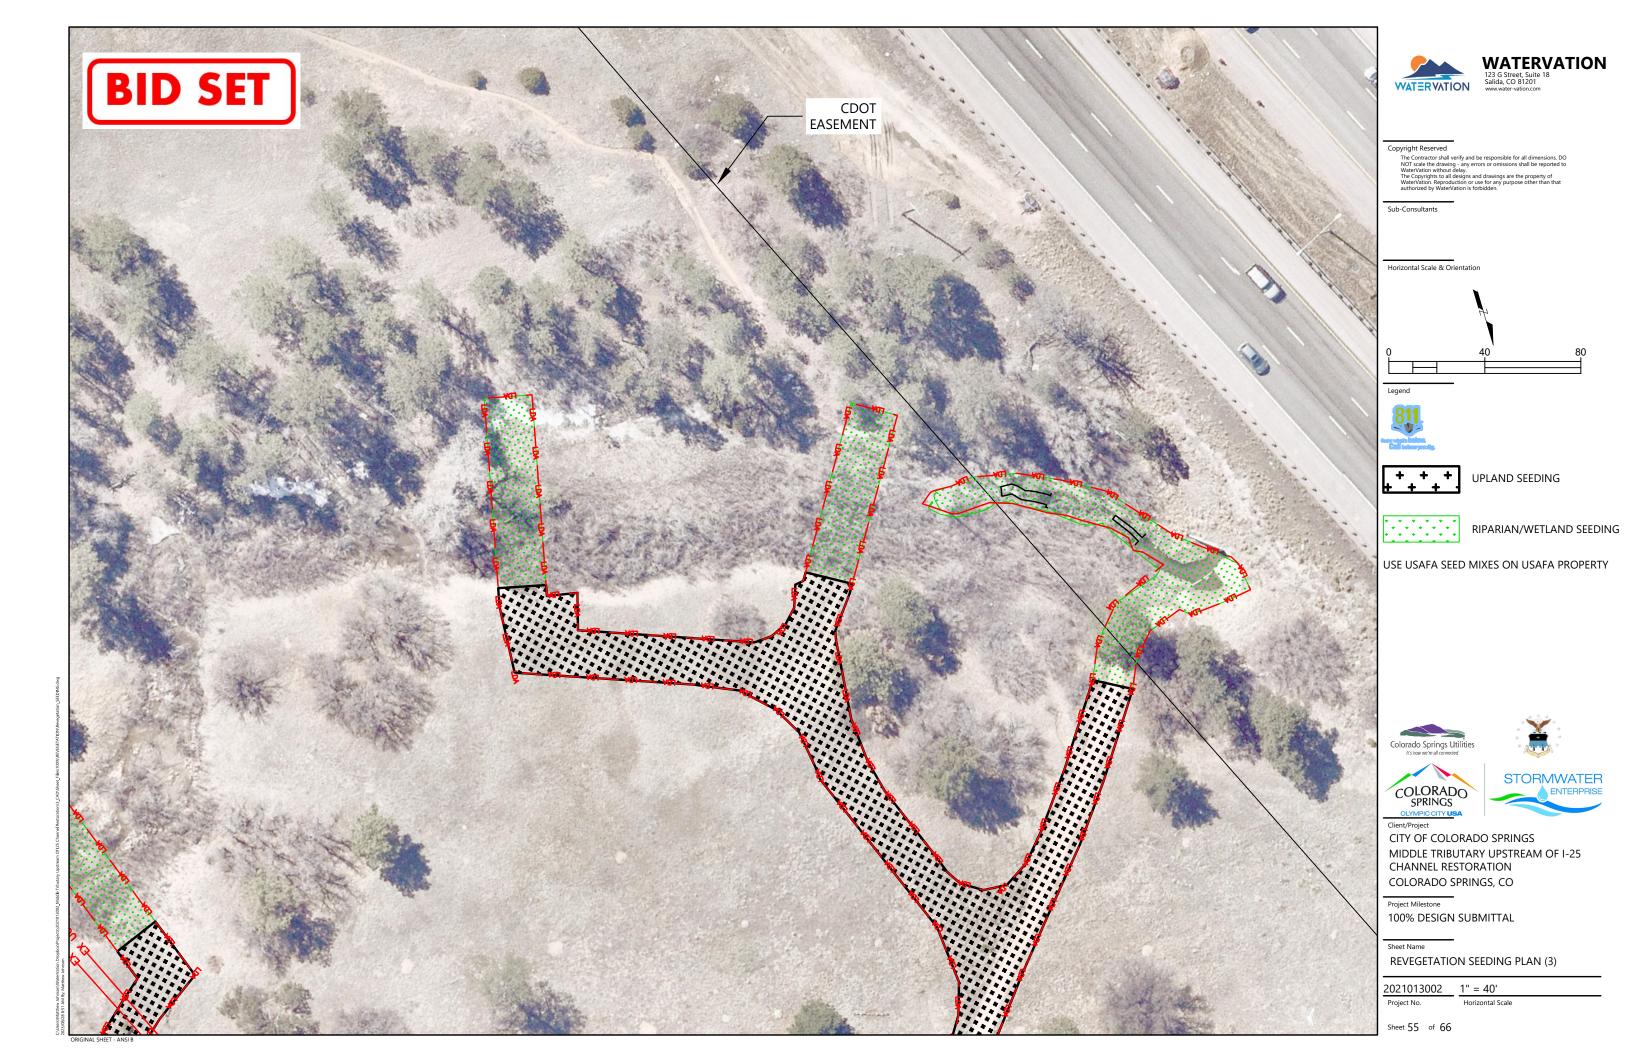






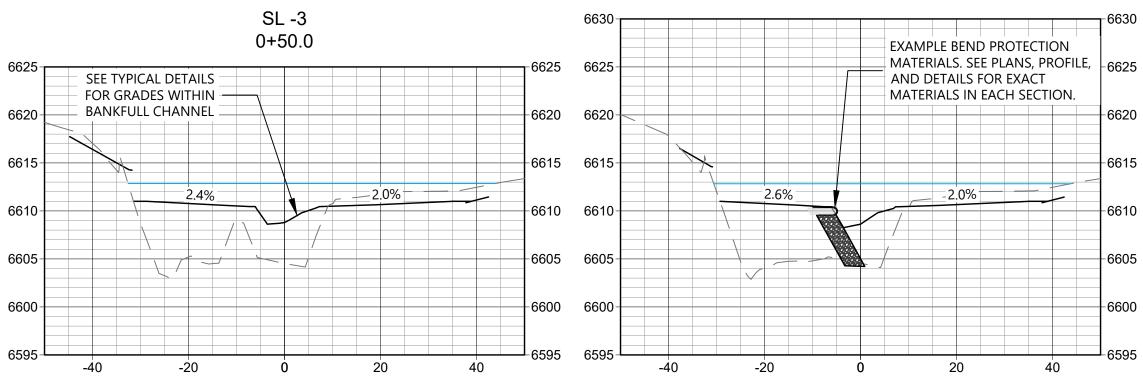



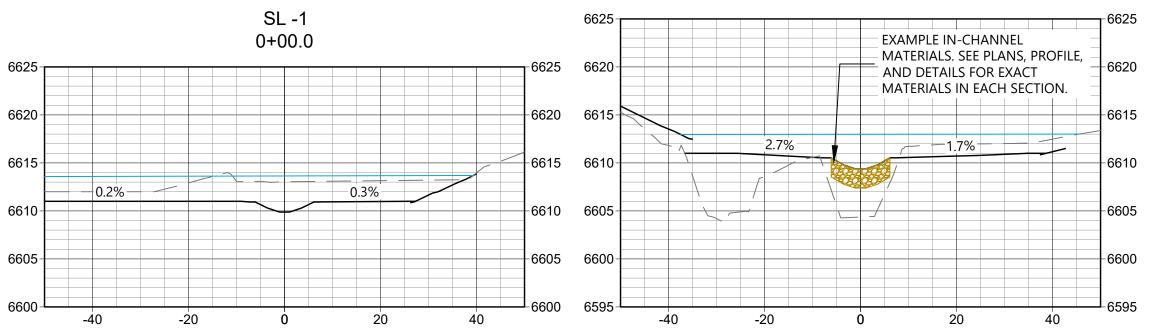



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100-YEAR WATER SURFACE **ELEVATION**







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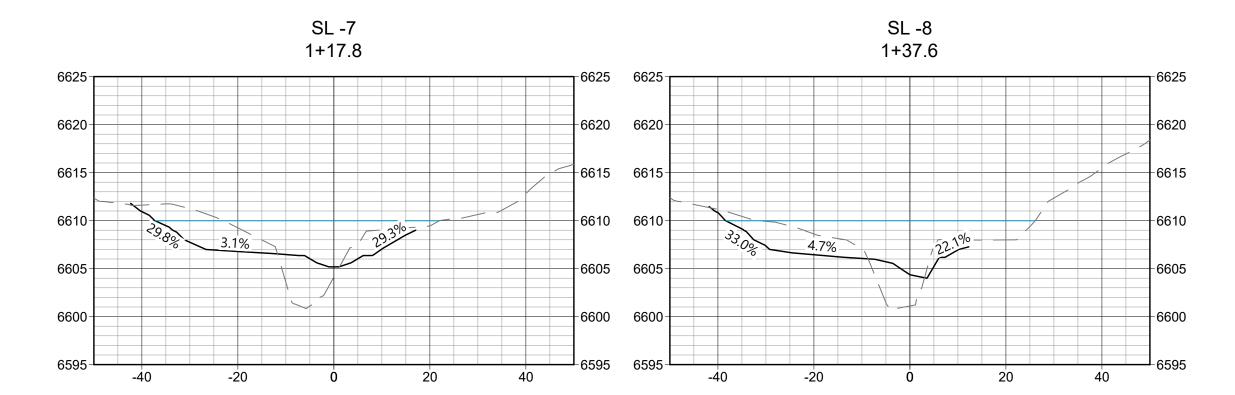
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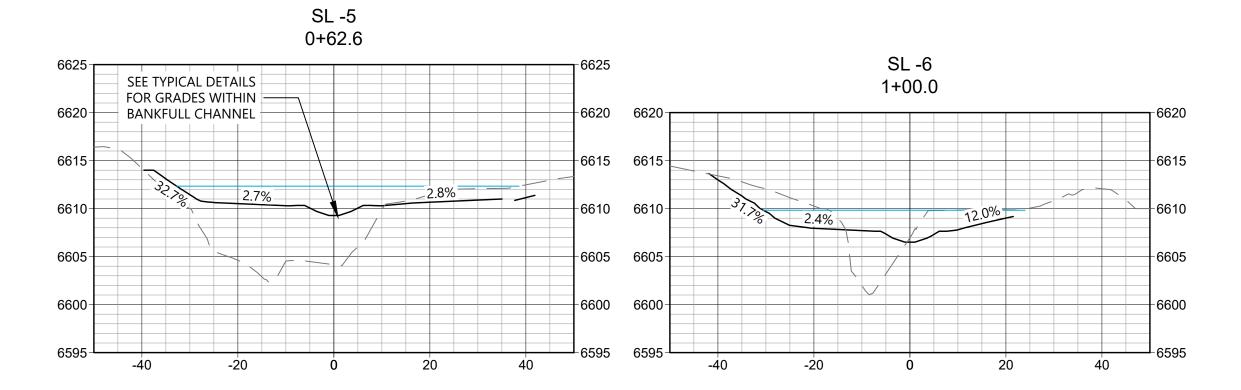
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Sheet 56 of 66









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100-YEAR WATER SURFACE **ELEVATION**







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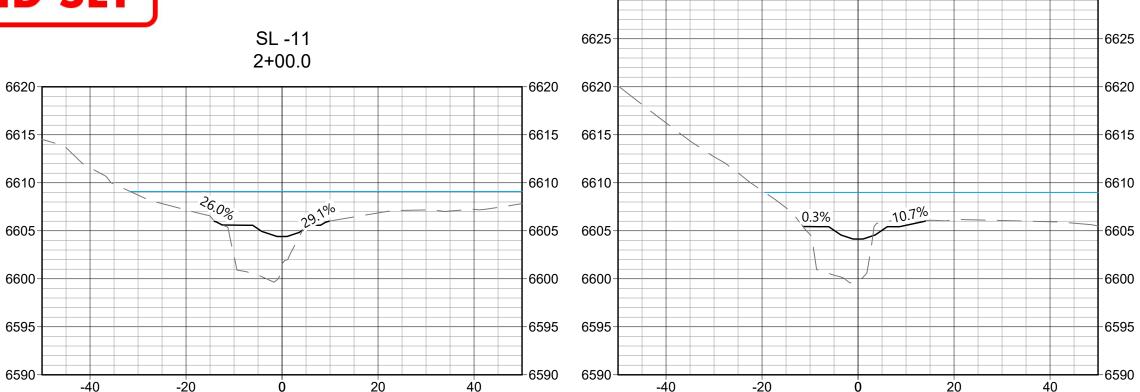
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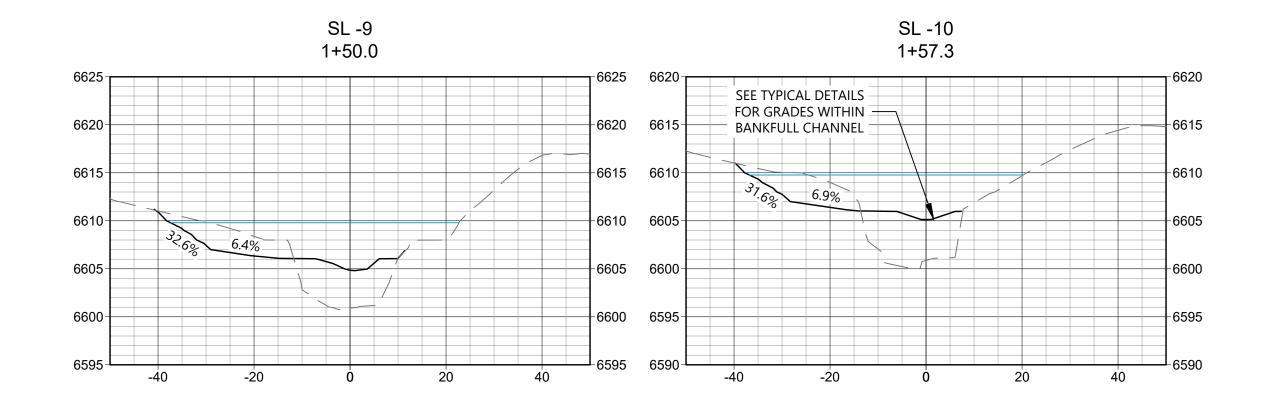
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100-YEAR WATER SURFACE ELEVATION







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CITY OF COLORADO SPRINGS MIDDLE TRIBUTARY UPSTREAM OF I-25 CHANNEL RESTORATION COLORADO SPRINGS, CO

Project Milestone

100% DESIGN SUBMITTAL

Sheet Name


SECTION SHEET - (3)

2021013002 1" = 20'

Project No.

Horizontal Scale

Sheet **58** of **66**

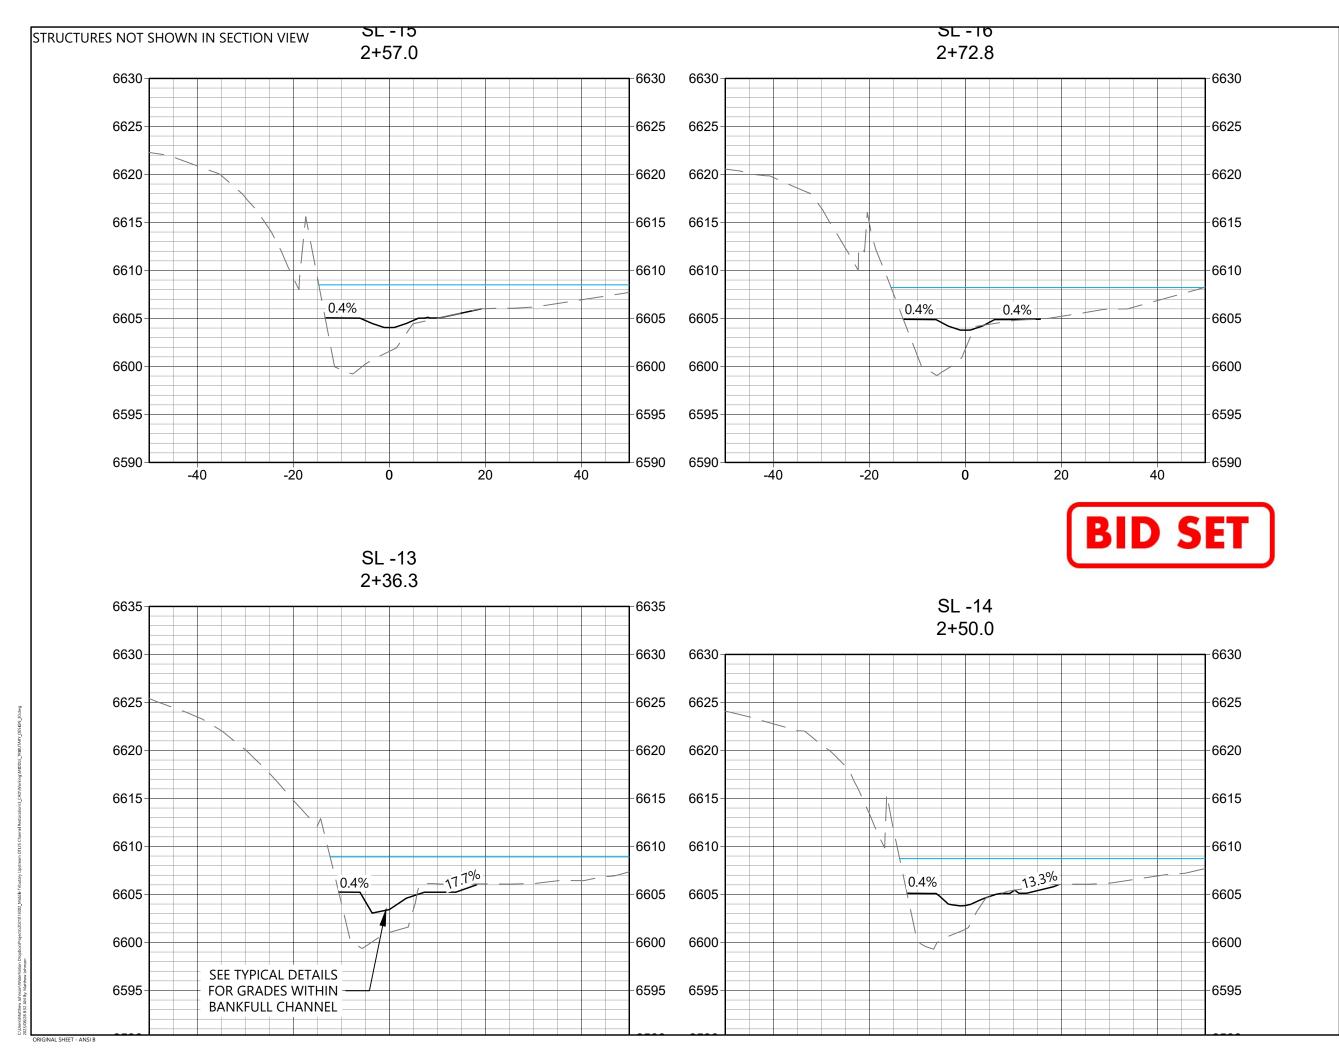



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Sub-Consultants

Horizontal Scale & Orientation

100-YEAR WATER SURFACE **ELEVATION**







Client/Project

CITY OF COLORADO SPRINGS MIDDLE TRIBUTARY UPSTREAM OF I-25 CHANNEL RESTORATION COLORADO SPRINGS, CO

Project Milestone

100% DESIGN SUBMITTAL

Sheet Name

SECTION SHEET - (4)

Project No.

2021013002 1"=20'

Sheet **59** of **66**







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Horizontal Scale & Orientation



100-YEAR WATER SURFACE **ELEVATION**







Client/Project

CITY OF COLORADO SPRINGS MIDDLE TRIBUTARY UPSTREAM OF I-25 CHANNEL RESTORATION COLORADO SPRINGS, CO

Project Milestone


100% DESIGN SUBMITTAL


Sheet Name

SECTION SHEET - (5)

2021013002 1" = 20' Project No.

Sheet 60 of 66

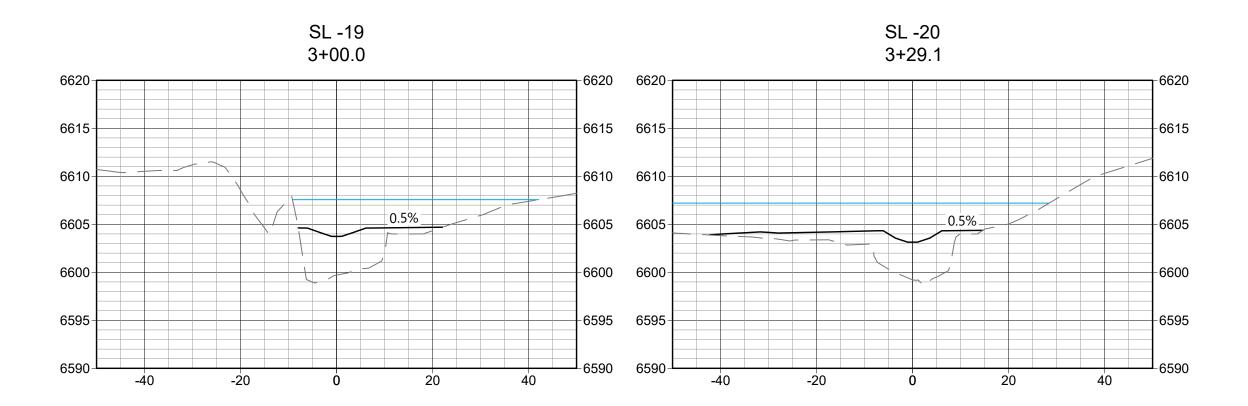


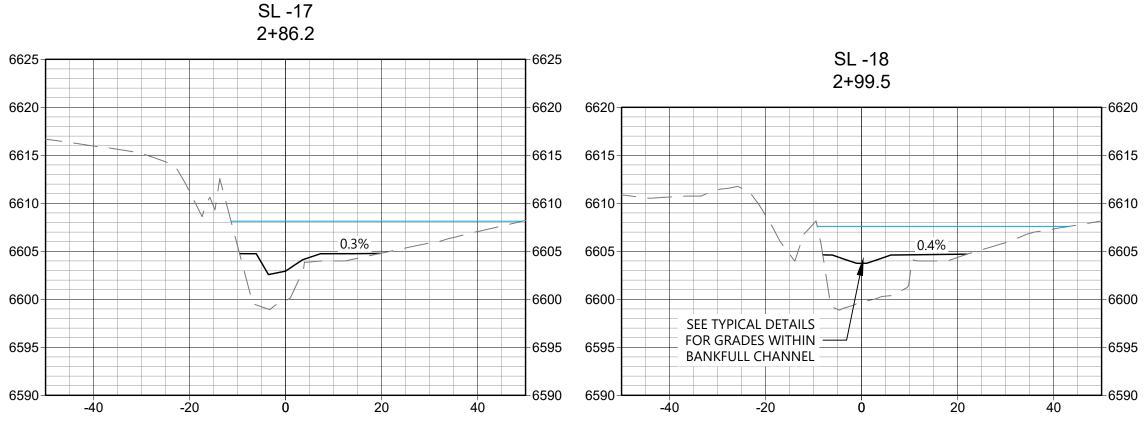








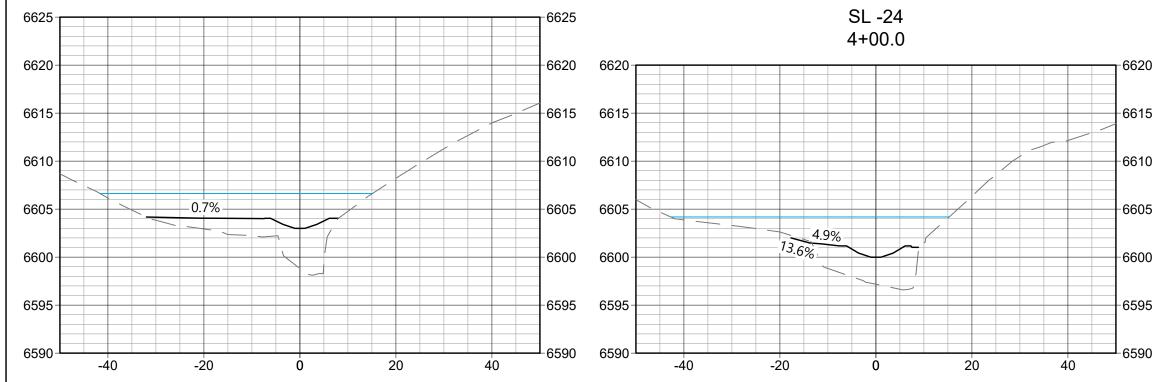



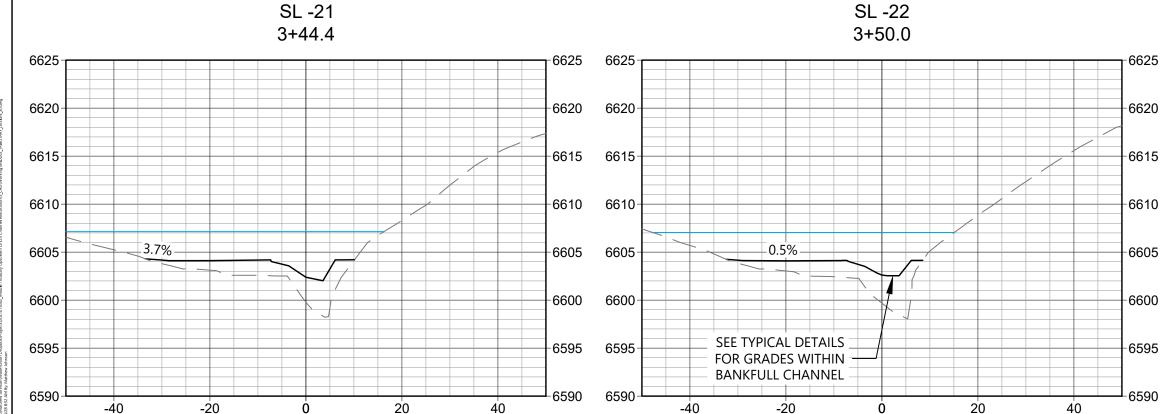



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Horizontal Scale & Orientation



100-YEAR WATER SURFACE **ELEVATION**







Client/Project

CITY OF COLORADO SPRINGS MIDDLE TRIBUTARY UPSTREAM OF I-25 CHANNEL RESTORATION COLORADO SPRINGS, CO

Project Milestone

100% DESIGN SUBMITTAL

Sheet Name

SECTION SHEET - (6)


2021013002 1" = 20'

Project No.


Sheet **61** of **66**





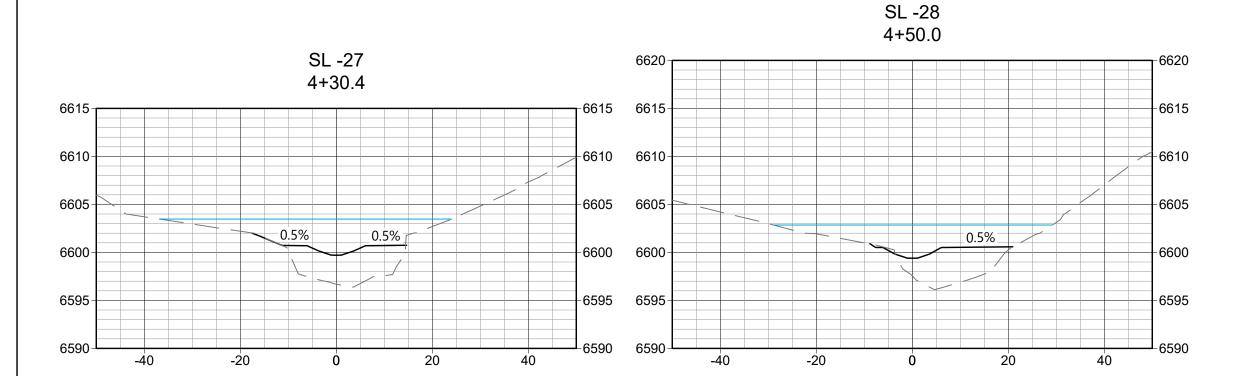

SL -26

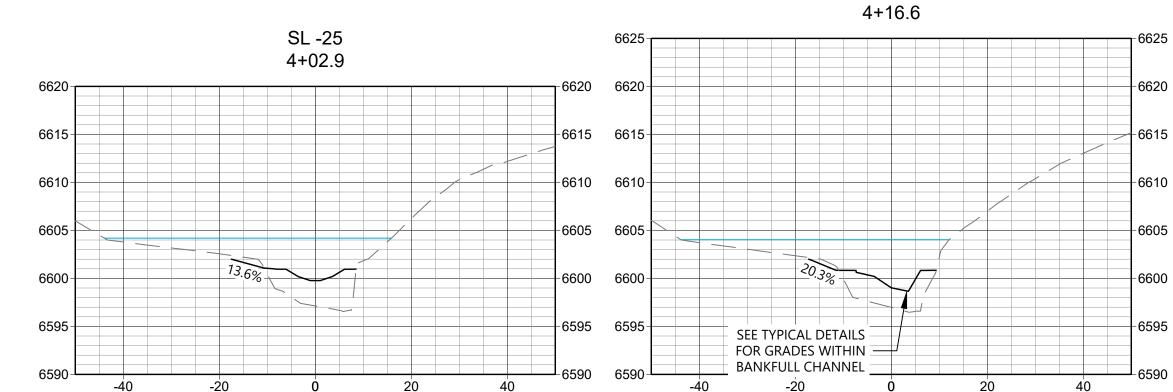

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Horizontal Scale & Orientation



100-YEAR WATER SURFACE **ELEVATION**







Client/Project

CITY OF COLORADO SPRINGS MIDDLE TRIBUTARY UPSTREAM OF I-25 CHANNEL RESTORATION COLORADO SPRINGS, CO

Project Milestone

100% DESIGN SUBMITTAL


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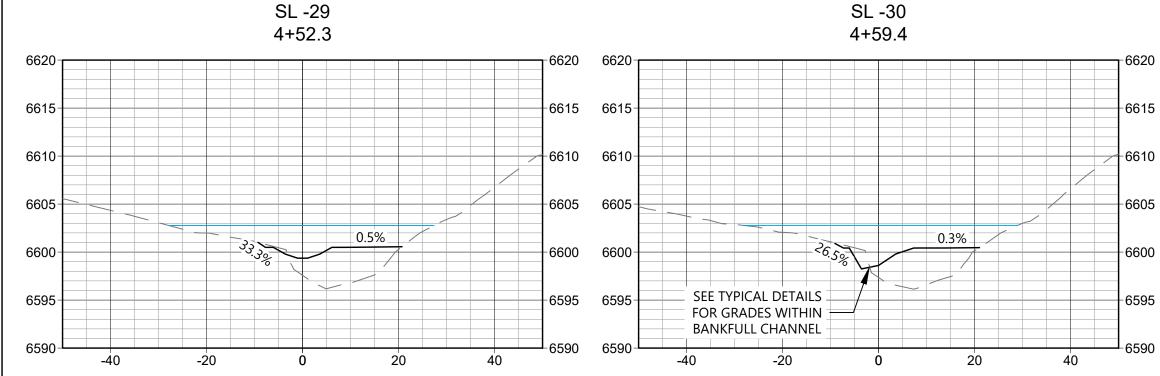
SECTION SHEET - (7)

2021013002 1" = 20' Project No.

Sheet 62 of 66





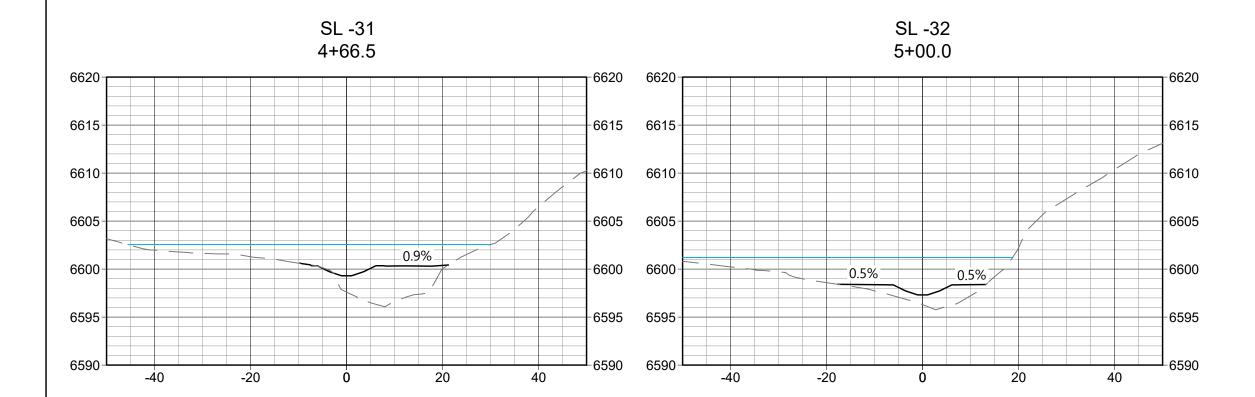



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Sub-Consultants

Horizontal Scale & Orientation

Legend 811

- 100-YEAR WATER SURFACE ELEVATION







Client/Project

CITY OF COLORADO SPRINGS MIDDLE TRIBUTARY UPSTREAM OF I-25 CHANNEL RESTORATION COLORADO SPRINGS, CO

Project Milestone

100% DESIGN SUBMITTAL

Sheet Name

SECTION SHEET - (8)


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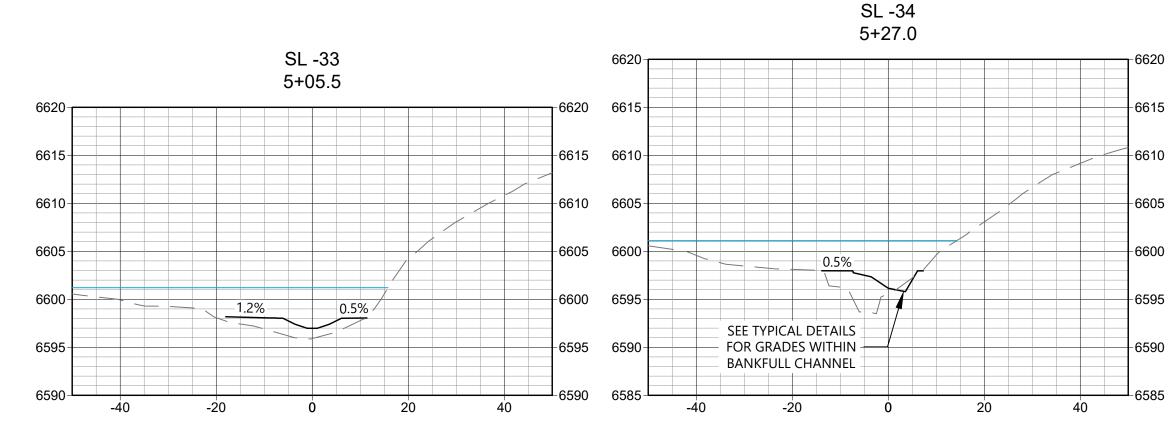
Project No. $\frac{1 = 20}{\text{Horizonta}}$

Sheet 63 of 66







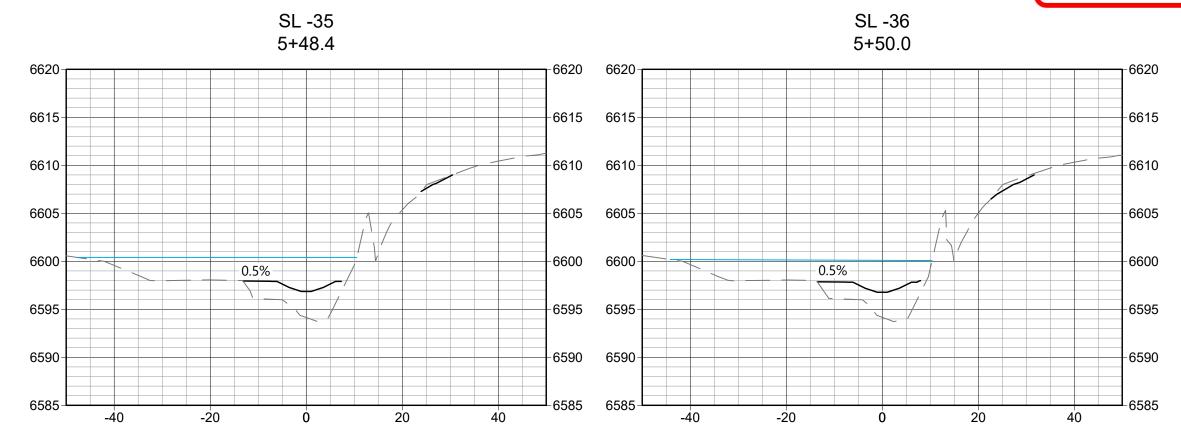



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Horizontal Scale & Orientation



100-YEAR WATER SURFACE **ELEVATION**







Client/Project

CITY OF COLORADO SPRINGS MIDDLE TRIBUTARY UPSTREAM OF I-25 CHANNEL RESTORATION COLORADO SPRINGS, CO

Project Milestone

100% DESIGN SUBMITTAL

Sheet Name

SECTION SHEET - (9)


2021013002 1" = 20' Project No.


Sheet **64** of **66**







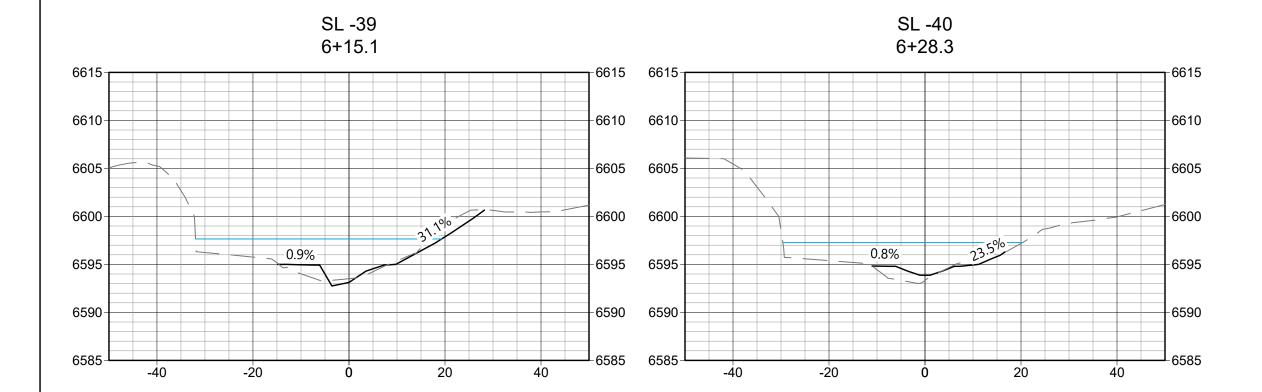

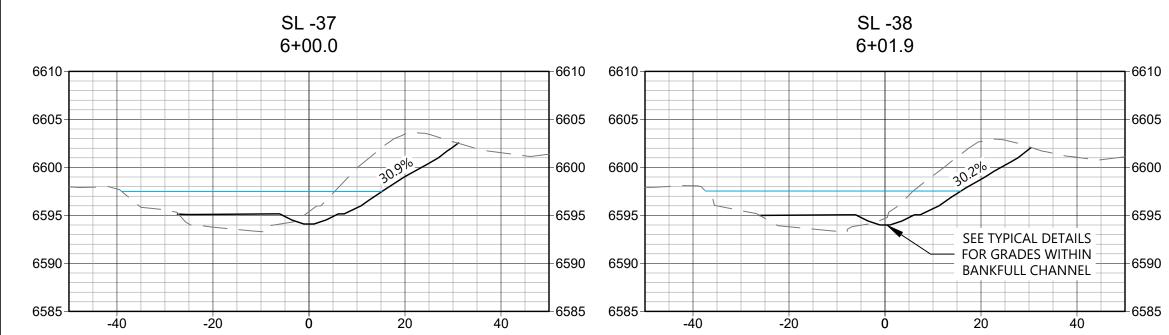



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Horizontal Scale & Orientation



100-YEAR WATER SURFACE **ELEVATION**







Client/Project

CITY OF COLORADO SPRINGS MIDDLE TRIBUTARY UPSTREAM OF I-25 CHANNEL RESTORATION COLORADO SPRINGS, CO

Project Milestone

100% DESIGN SUBMITTAL

Sheet Name

SECTION SHEET - (10)

2021013002 1" = 20' Project No.

Sheet **65** of **66**

STRUCTURES NOT SHOWN IN SECTION VIEW



SL -42



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Horizontal Scale & Orientation

100-YEAR WATER SURFACE **ELEVATION**







Client/Project

CITY OF COLORADO SPRINGS MIDDLE TRIBUTARY UPSTREAM OF I-25 CHANNEL RESTORATION COLORADO SPRINGS, CO

Project Milestone

100% DESIGN SUBMITTAL

Sheet Name

SECTION SHEET - (11)

2021013002 1" = 20' Project No.

Sheet 66 of 66

